

# Hilliard Township Office Addition - Phase 1

22013  
951678 HWY 569,  
HILLIARDTON, ON, POJ ILO

## REV 2 - ISSUED FOR TENDER

### DRAWING LIST

No.	REV.	DRAWING TITLE
A1	1	PROJECT NOTES & ASSEMBLY TYPES
A2	1	LIFE SAFETY PLAN
A3	1	SITE PLAN
A4	1	DEMOLITION FLOOR PLAN
A5	1	ADDITION FOUNDATION PLAN
A6	2	ADDITION FLOOR PLAN
A7	1	ADDITION ROOF PLAN
A8	2	EXTERIOR ELEVATIONS
A9	1	BUILDING SECTIONS & DETAILS
A10	1	WINDOW & DOOR SCHEDULES
A11	2	EXTERIOR VIEWS



**ryancompanyarchitectinc**



DATE STAMP: 2023-07-26 11:29:11 AM

23.07.26 | DATE  
Issued for Tender | 2 | REVISION

HILLIARD TOWNSHIP OFFICE ADDITION - PHASE 1




Item	Ontario Building Code Data Matrix Parts 3 & 9	OBC Reference
1	Project Description: <input type="checkbox"/> New <input type="checkbox"/> Part 11 <input checked="" type="checkbox"/> Part 3 <input type="checkbox"/> Part 9 <input type="checkbox"/> Change of Use <input checked="" type="checkbox"/> Addition <input type="checkbox"/> Alteration	2.1.1 9.10.1.3
2	Major Occupancy(s) A2, F3, D	3.1.2.1.(1) 9.10.2
3	Building Area (m <sup>2</sup> ) Existing <u>330.00</u> New <u>40.14</u> Total <u>370.14</u>	1.1.3.2 1.1.3.2
4	Gross Area Existing <u>495.00</u> New <u>40.14</u> Total <u>535.14</u>	1.1.3.2 1.1.3.2
5	Number of Storeys Above grade <u>2</u> Below grade <u>0</u>	3.2.1.1 & 1.1.3.2 2.1.1.3
6	Height of Building (m)	2.1.1.3
7	Number of Streets/Access Routes	3.2.2.10 & 3.2.5.5
8	Building Classification	3.2.2.20-83 9.10.4
9	Sprinkler System Proposed <input type="checkbox"/> entire building <input type="checkbox"/> basement only <input type="checkbox"/> in lieu of roof rating <input checked="" type="checkbox"/> not required	3.2.2.20-83 3.2.1.5 3.2.2.17
10	Standpipe required <input type="checkbox"/> Yes <input checked="" type="checkbox"/> No	3.2.9
11	Fire Alarm required <input type="checkbox"/> Yes <input checked="" type="checkbox"/> No	3.2.4
12	Water Service/Supply is Adequate <input checked="" type="checkbox"/> Yes <input type="checkbox"/> No	
13	High Building <input type="checkbox"/> Yes <input checked="" type="checkbox"/> No	3.2.6
14	Permitted Construction <input checked="" type="checkbox"/> Combustible <input checked="" type="checkbox"/> Non-combustible Actual Construction <input checked="" type="checkbox"/> Combustible <input type="checkbox"/> Non-combustible	3.2.2.20-83 9.10.6
15	Mezzanine(s) Area m <sup>2</sup>	3.2.1.1.(3)-(8) 9.10.4.1
16	Occupant load based on <input type="checkbox"/> m <sup>2</sup> /person <input type="checkbox"/> design of building Basement: Occupancy _____ Load _____ persons 1 <sup>st</sup> Floor: Occupancy _____ Load _____ persons 2 <sup>nd</sup> Floor: Occupancy _____ Load _____ persons 3 <sup>rd</sup> Floor: Occupancy _____ Load _____ persons	3.1.1.6 9.9.1.3
17	Barrier-free Design <input checked="" type="checkbox"/> Yes <input type="checkbox"/> No (Explain)	3.8 9.5.2
18	Hazardous Substances <input type="checkbox"/> Yes <input checked="" type="checkbox"/> No	3.3.1.2.(1) & 3.3.1.19(1) 9.10.1.3
19	Required Fire Resistance Rating (FRR) Horizontal Assemblies FRR (Hours) _____ Listed Design No. or Description (SG-2) _____ Floors Exist _____ Hours _____ Roof _____ 3/4 Hours _____ Mezzanine NA Hours _____ FRR of Supporting Members _____ Listed Design No. Or Description (SG-2) _____ Floors Exist _____ Hours _____ Roof _____ Hours _____ Mezzanine _____ Hours _____	3.2.2.20-83 & 3.2.1.4 9.10.8 9.10.9
20	Spatial Separation – Construction of Exterior Walls	3.2.3 9.10.14
	Wall Area of EBF (m <sup>2</sup> ) L.D. (m) L/H or H/L Permitted Max. % of Openings Proposed % of Openings FRR (Hours) Listed Design or Description Comb Const Comb. Constr. Non-comb. Constr.	
	North 21.3 5 4:1 70 14 3/4 SB-2 YES	
	South NA NA 4:1 100 0 3/4 SB-2 YES	
	East 16.4 11.5 3:1 100 15 3/4 SB-2 YES	
	West 16.4 8.6 3:1 100 7 3/4 SB-2 YES	
21	Other – Describe	

**SB-10 ENERGY EFFICIENCY REQUIREMENTS:**  
THE ENERGY EFFICIENCY PERFORMANCE REQUIREMENTS OF THE BUILDINGS ENVELOPE, HEATING, AIR CONDITIONING, VENTILATION AND LIGHTING SHALL COMPLY TO CHAPTER 3, DIVISION 3 OF SB-10, OBC 2012.


**DESIGN CRITERIA:**  
VALUES BELOW ARE PROVIDED FOR NEW LISKEARD AS PER TABLE 1.2 OF SB-10 IN THE OBC.  
- SNOW LOAD (1/50): S<sub>s</sub> = 2.6 kPa, S<sub>r</sub> = 0.4 kPa  
- HOURLY WIND PRESSURES: 1/10 = 0.33 kPa, 1/50 = 0.43 kPa  
- SEISMIC DATA: S<sub>a</sub> (0.2) = 0.220

SPECIFIED SNOW LOAD = S = C<sub>s</sub> x S<sub>s</sub> + S<sub>r</sub>, WHERE:  
C<sub>s</sub> = 0.45 FOR ROOF WIDTH ≤ 4.3 m, 0.55 FOR WIDTH > 4.3 m  
S<sub>s</sub> = 1-in-50 YEAR GROUND SNOW LOAD IN kPa  
S<sub>r</sub> = 1-in-50 YEAR RAIN LOAD IN kPa

S = 0.55 x 2.6 + 0.4 = 1.83 kPa

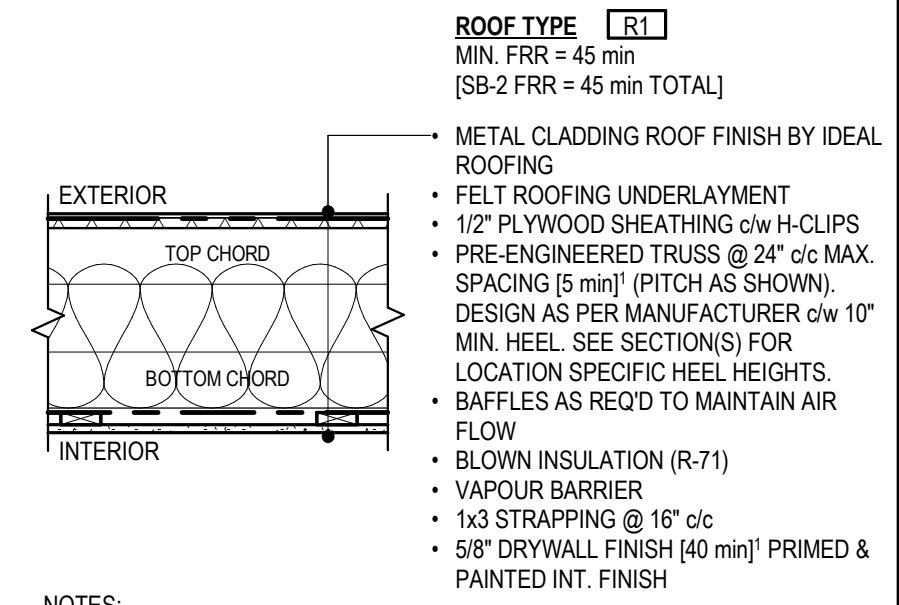


**TYPICAL ROOF TYPES**

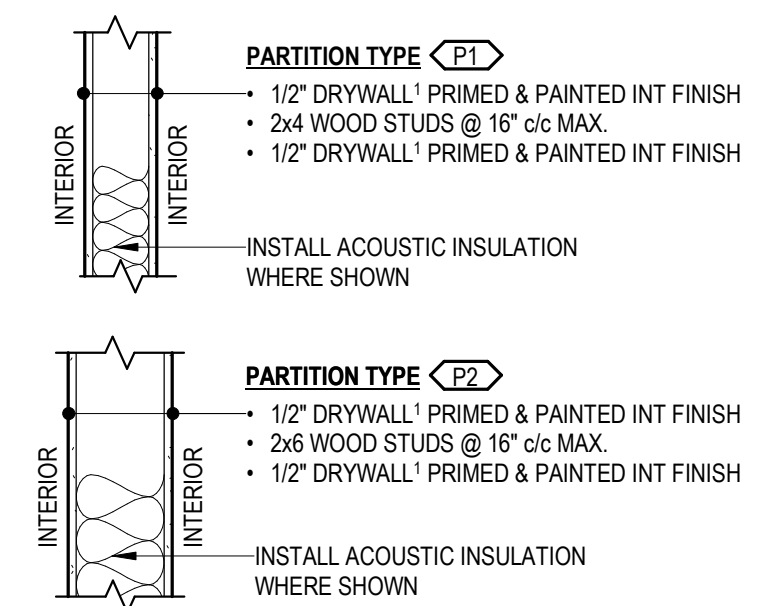


NOTE: ALL UNTAGGED PARTITIONS SHOWN IN PLANS SHALL BE TYPE 'P1' UNLESS TAGGED OTHERWISE.  
1. INSTALL MOISTURE RESISTANT DRYWALL IN ALL WET AREAS.  
2. INSTALL VINYL/RUBBER WALL BASE AS PER MANUF. SPECS.


**TYPICAL PARTITION TYPES**

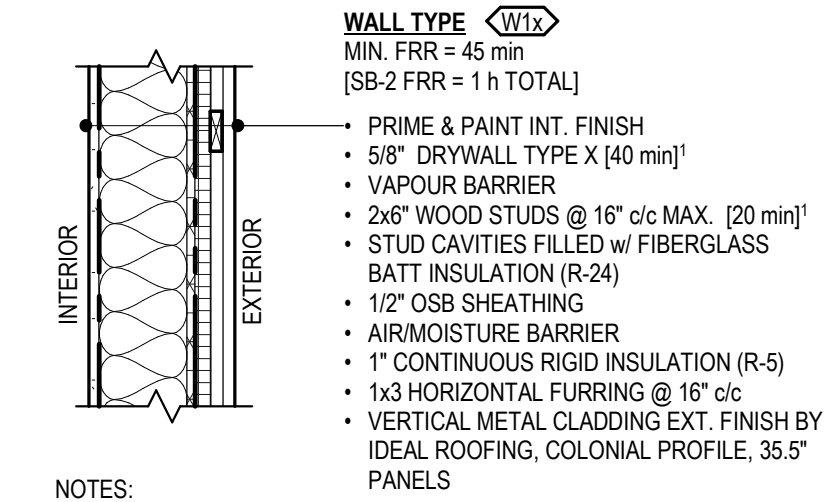

**TYPICAL WALL TYPES**

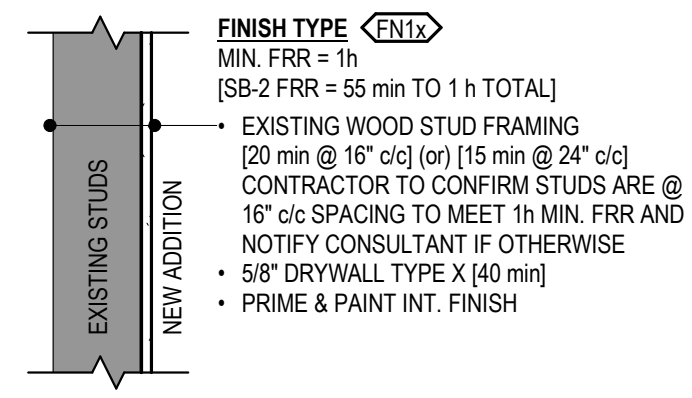

**TYPICAL FINISH TYPES**

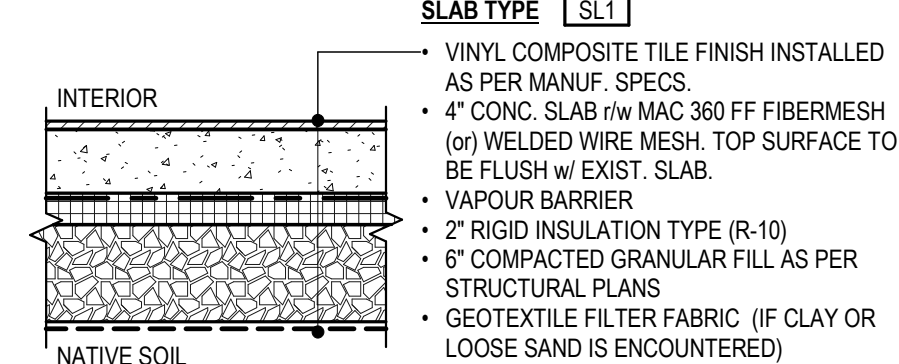

**TYPICAL SLAB TYPES**

**ABBREVIATIONS:**

AFFL. ABOVE FINISH FLOOR LEVEL	FRR. FIRE RESISTANCE RATING	O.H. OVERHANG
ALUM. ALUMINUM	FTG. FOOTING	P.T. PRESSURE TREATED
CANT. CANTILEVER	GRAN. GRANULAR	REQ'D REQUIRED
c/c CENTER TO CENTER	H HORIZONTAL	r/w REINFORCED WITH
CL CENTERLINE	hr HOUR	SPEC'D SPECIFIED
CMU CONCRETE MASONRY UNIT	ICF INSULATION CONCRETE FORM	SPECS SPECIFICATIONS
CONC. CONCRETE	MANUF. MANUFACTURER	T/G TONGUE AND GROOVE
c/w COMPLETE WITH	MAX. MAXIMUM	TYP. TYPICAL
DWG DRAWING	MIN. MINIMUM	U.N.O. UNLESS NOTED OTHERWISE
ELEV. ELEVATION	min MINUTE	v VERTICAL
EXIST. EXISTING	N.I.C. NOT IN CONTRACT	w/ WITH
FDN FOUNDATION	OBC ONTARIO BUILDING CODE	w/o WITHOUT

**GENERAL PROJECT NOTES:**  
A. PROJECT SHALL BE CONSTRUCTED IN STRICT COMPLIANCE WITH THE LATEST EDITION OF THE ONTARIO BUILDING CODE, (LATEST REVISIONS INCLUDED), ALL LOCAL BY-LAWS, ACTS AND ORDINANCES.  
B. PERFORM ALL WORK IN ACCORDANCE WITH THE ONTARIO BUILDING CODE AS A MINIMUM STANDARD, REFER TO APPROPRIATE CSA STANDARDS FOR ADDITIONAL REQUIREMENTS COVERING WORKMANSHIP AND MATERIALS.  
C. ALL WORK SHALL CONFORM TO ALL APPLICABLE BY-LAWS AND OTHER CODES AND BODIES HAVING JURISDICTION.  
D. ALL WORKMANSHIP SHALL BE IN COMPLIANCE WITH GOOD TRADE PRACTICES.  
E. THE CONTRACTOR SHALL BE SOLELY RESPONSIBLE FOR THE STRUCTURAL INTEGRITY OF THE BUILDING DURING ALL PHASES OF THE CONSTRUCTION.  
F. THE CONTRACTOR SHALL VERIFY ALL DIMENSIONS AND REPORT ANY DISCREPANCIES TO THE DESIGNER BEFORE PROCEEDING WITH THE CONSTRUCTION.  
G. TRUSS HEEL HEIGHT TO BE 10" MIN. (U.N.O.). SEE BUILDING SECTIONS FOR LOCATION SPECIFIC HEEL HEIGHTS.

**FLASHING AND VENTILATION NOTES:**  
**ROOF FLASHING:**  
• INSTALL ROOF FLASHING AT ALL VALLEYS, WALL INTERSECTIONS AND JUNCTIONS WHERE WATER COULD PENETRATE ROOF DECKING.  
**VENTILATION:**  
• UNIFORMLY DISTRIBUTE ROOF VENTS ON OPPOSITE SIDES OF THE BUILDING FOR ADEQUATE CROSS VENTILATION WITH NOT LESS THAN 25% OF THE REQ'D OPENINGS LOCATED AT THE TOP OF THE ROOF SPACE AND NOT LESS THAN 25% OF THE REQ'D OPENINGS LOCATED AT THE BOTTOM OF THE ROOF SPACE.

**CONCRETE NOTES:**  
A. WORK IN THIS SECTION SHALL COMPLY WITH THE REQUIREMENTS OF CSA A23.1-94 AND CSA A23.2-94 AS MINIMUM STANDARDS.  
B. CONSTRUCT FORMWORK STRONG, TIGHT, BRACED AND TRUE SO AS TO MAINTAIN SHAPE AND POSITION. USE ONLY NEW MATERIALS.  
C. ALL REINFORCING STEEL TO BE CLEAN AND SECURED IN PLACE BY THE USE OF CHAIRS, SPACERS, OR HANGERS.  
D. ALL ROCK SURFACES, IF ANY, WHICH ARE TO BE IN CONTACT WITH CONCRETE SHALL BE THOROUGHLY CLEANED OF ANY LOOSE OR FRACTURED ROCK.  
E. PROVIDE A MINIMUM 9" LAP FOR WELDED WIRE MESH.  
F. 1/4" SAW CUT FOR CONTROL JOINTS 1-1/2" DEEP MAXIMUM.

**FOUNDATION MATERIALS**  
A. CONCRETE:  
a. MIN. COMPRESSIVE STRENGTH:  
FOUNDATION WALLS = 20 MPa  
FOOTING = 32 MPa  
GARAGE & EXTERIOR SLABS = 32 MPa  
INTERIOR SLABS & CONCRETE TOPPING = 20 MPa  
FLOOR TOPPING = 20 MPa  
b. AIR ENTRAINMENT: 5-8% FOR GARAGE AND EXTERIOR SLABS  
B. GRANULAR 'A' COMPACTION RATING = 100 % S.P.M.D.D.  
C. GRANULAR 'B' COMPACTION RATING = 95 % S.P.M.D.D.  
D. REINFORCING BARS: BILLET STEEL BARS, GRADE 400 TO CAN/CSA 30.12.  
E. NON-SHRINK, NON METALLIC GROUT: M-BED BY STERNSON.

**SHOP DRAWINGS:**  
A. SUBMIT A MINIMUM OF ONE (1) COPY OF SHOP DRAWINGS OF ALL EQUIPMENT, FIXTURES, DOORS AND WINDOWS SPECIFIED UNDER THIS CONTRACT FOR THE CONSULTANT'S REVIEW PRIOR TO PLACING PURCHASE ORDERS. REVIEWED SHOP DRAWINGS ARE DEEMED AS EVIDENCE OF ACCEPTANCE OF SUBMITTED PRODUCT. SHOP DRAWINGS WILL BE RETURNED ELECTRONICALLY.

**SITE AND SOILS NOTES:**  
A. SOIL BEARING CAPACITY ASSUMED TO BE 75 kPa MIN. FOR DESIGN PURPOSES.  
B. IF ACTUAL SOIL CONDITIONS FOUND ON SITE ARE SUBSTANTIALLY DIFFERENT THAN ANTICIPATED, MODIFICATIONS TO THE FOUNDATION DESIGN MAY BE REQUIRED.  
C. THE CONTRACTOR MUST ENSURE ADEQUATE SITE DRAINAGE AWAY FROM ALL BUILDINGS AND STRUCTURES.

**CARPENTRY NOTES:**  
A. WOOD FRAMING SHALL CONFORM TO THE REQUIREMENTS OF PART 9 OF THE ONTARIO BUILDING CODE AND SHALL BE RIGIDLY AND SECURELY CONNECTED, REFER SPECIFICALLY TO TABLE 9.23.3.A FOR NAILING PRACTICE IN GENERAL.  
B. MISCELLANEOUS FRAMING LUMBER SHALL BE NO. 2 GRADE OR BETTER SPRUCE, PINE OR FIR SPECIES TO C.S.A. STANDARD 0141-1970.  
C. ALL LUMBER EXPOSED TO THE ELEMENTS SHALL BE PRESSURE TREATED AND ALL CUTS SHALL BE TREATED WITH A WATERPROOFING SEALANT.  
D. SHEATHING MATERIAL SHALL BE FIR PLY IN LOCATIONS AND TO THICKNESSES AS NOTED ON DRAWINGS.  
E. SUPPORT ALL WINDOW AND DOOR LINTELS WITH A SPAN MORE THAN 3 m (9'-10") WITH (2x) JACK STUDS ON BOTH SIDES OF OPENING (UNLESS NOTED OTHERWISE).  
F. THE WIDTH OF COLUMNS AND STUD POSTS SHALL BE NOT LESS THAN THE WIDTH OF THE GIRDER TRUSS OR BEAM THAT IT SUPPORTS.  
G. ALL COLUMNS AND STUD POSTS SHALL EXTEND DOWN TO FOUNDATION FOR SUFFICIENT BEARING. PROVIDE SOLID WOOD BLOCKING WHERE REQUIRED TO ENSURE A CONTINUOUS TRANSFER OF THE SUPPORTED LOADS.  
H. PREFABRICATED HANGERS AND FRAMING CONNECTORS TO BE INSTALLED IN ACCORDANCE WITH THE MANUFACTURER'S INSTRUCTIONS. FILL ALL NAIL/SCREW HOLES WITH CONNECTORS SPECIFIED BY MANUFACTURER.  
I. ALL FASTENERS EXPOSED TO THE ELEMENTS SHALL BE CORROSION RESISTANT.  
J. ALL EXTERIOR WALL SILL PLATES SHALL BE INSTALLED ON A FOAM GASKET. ALL INTERIOR PARTITION SILL PLATES INSTALLED ON CONCRETE SHALL BE INSTALLED ON A 2 mil POLYETHYLENE FILM (or) TYPE S ROLL ROOFING.

**PAINTING:**  
A. PAINT SHALL BE BENJAMIN MOORE FIRST LINE QUALITY LABEL (or) APPROVED ALTERNATE.  
B. PAINT ON THE FOLLOWING INTERIOR FINISHES SHALL BE:  
C. PREVIOUSLY PAINTED SURFACES:  
a. GYPSUM BOARD - GYPSUM WALL BOARD, DRYWALL, "SHEET ROCK TYPE MATERIAL", AND TEXTURED FINISHES:  
• NEW SURFACES:  
- FINISH: EGG SHELL ON WALLS, FLAT ON CEILINGS (OR MATCH EXISTING ADJACENT FINISH)  
- ONE (1) COAT, INTERIOR ACRYLIC LATEX PRIMER  
- TWO (2) COATS, INTERIOR 100% ACRYLIC LATEX PAINT  
D. DOORS:  
a. SOLID CORE, FLUSH STYLE DOOR  
• FINISH: EGG SHELL ON WALLS, FLAT ON CEILINGS (OR MATCH EXISTING ADJACENT FINISH)  
- ONE (1) COAT, INTERIOR ACRYLIC LATEX PRIMER  
- TWO (2) COATS, INTERIOR 100% ACRYLIC LATEX PAINT


**ROOF TRUSSES & SHEATHING:**  
A. TRUSS MANUFACTURER TO PROVIDE FINAL TRUSS LAYOUT TO RIVARC PRIOR TO FABRICATION.  
B. TRUSS MANUFACTURER TO PROVIDE LVL LINTELS FOR OPENINGS AS SHOWN IN DOOR & WINDOW SCHEDULES.  
C. PRE-ENGINEERED TRUSSES (WHERE SHOWN) ARE FOR REFERENCE ONLY. FINAL DESIGN AND LAYOUT PROVIDED BY MANUFACTURER.  
D. PRE-ENGINEERED TRUSSES TO BE ENGINEERED, INSTALLED, BRACED AND CONNECTED AS PER MANUFACTURER'S SPECIFICATIONS AND APPLICABLE ONTARIO BUILDING CODE REQUIREMENTS.  
E. NEVER CUT, NOTCH OR DRILL A PRE-ENGINEERED TRUSS TO OBTAIN SPACE, UNLESS ACCOMMODATED FOR IN MANUFACTURER'S DESIGN.  
F. IF TONGUE AND GROOVE TYPE SHEATHING IS NOT USED, SHEATHING EDGES PARALLEL TO ROOF RIDGE SHALL BE SUPPORTED BY METAL "H" CLIPS IN EACH TRUSS SPACE.




DATE STAMP: 2023-07-26 11:29:12 AM FILE PATH: D:\RIVARC\_Sharing\Projects\22013 Hilliard Town Office Addition 2 Working Models\22013\_HilliardTownOfficeAddition\_Model.rvt

<p><b>rivarc</b> — DRAFTING &amp; DESIGN — sean@rivarc.ca   705.648.3155   rivarc.ca</p>	Plan Orientation	Rev. Description 1 Issued for Tender	Date 23.07.26	Client Hilliard TOWNSHIP Since 1910	Drawing Title <b>PROJECT NOTES &amp; ASSEMBLY TYPES</b> Project Title HILLIARD TOWNSHIP OFFICE ADDITION - PHASE 1 951678 Hwy 569, Hilliardton, ON, P0J 1L0	Professional Stamp *I REVIEWED THIS DOCUMENT AND TAKE RESPONSIBILITY FOR THIS DESIGN. I AM QUALIFIED, AND THE FIRM IS REGISTERED, IN THE APPROPRIATE CLASSIFICATION AS PER SUBSECTION 3.2.4 OF DIVISION C OF THE BUILDING CODE.* rivarc Sean Rivard BCIN # 110013 BCIN # 102394 SIGNATURE	Scale As indicated	Project No. 22013
	Sheet Size 18 x 24"	Date 23.07.26	Revision 1	Drawing No. A1	Drawn By SWR			



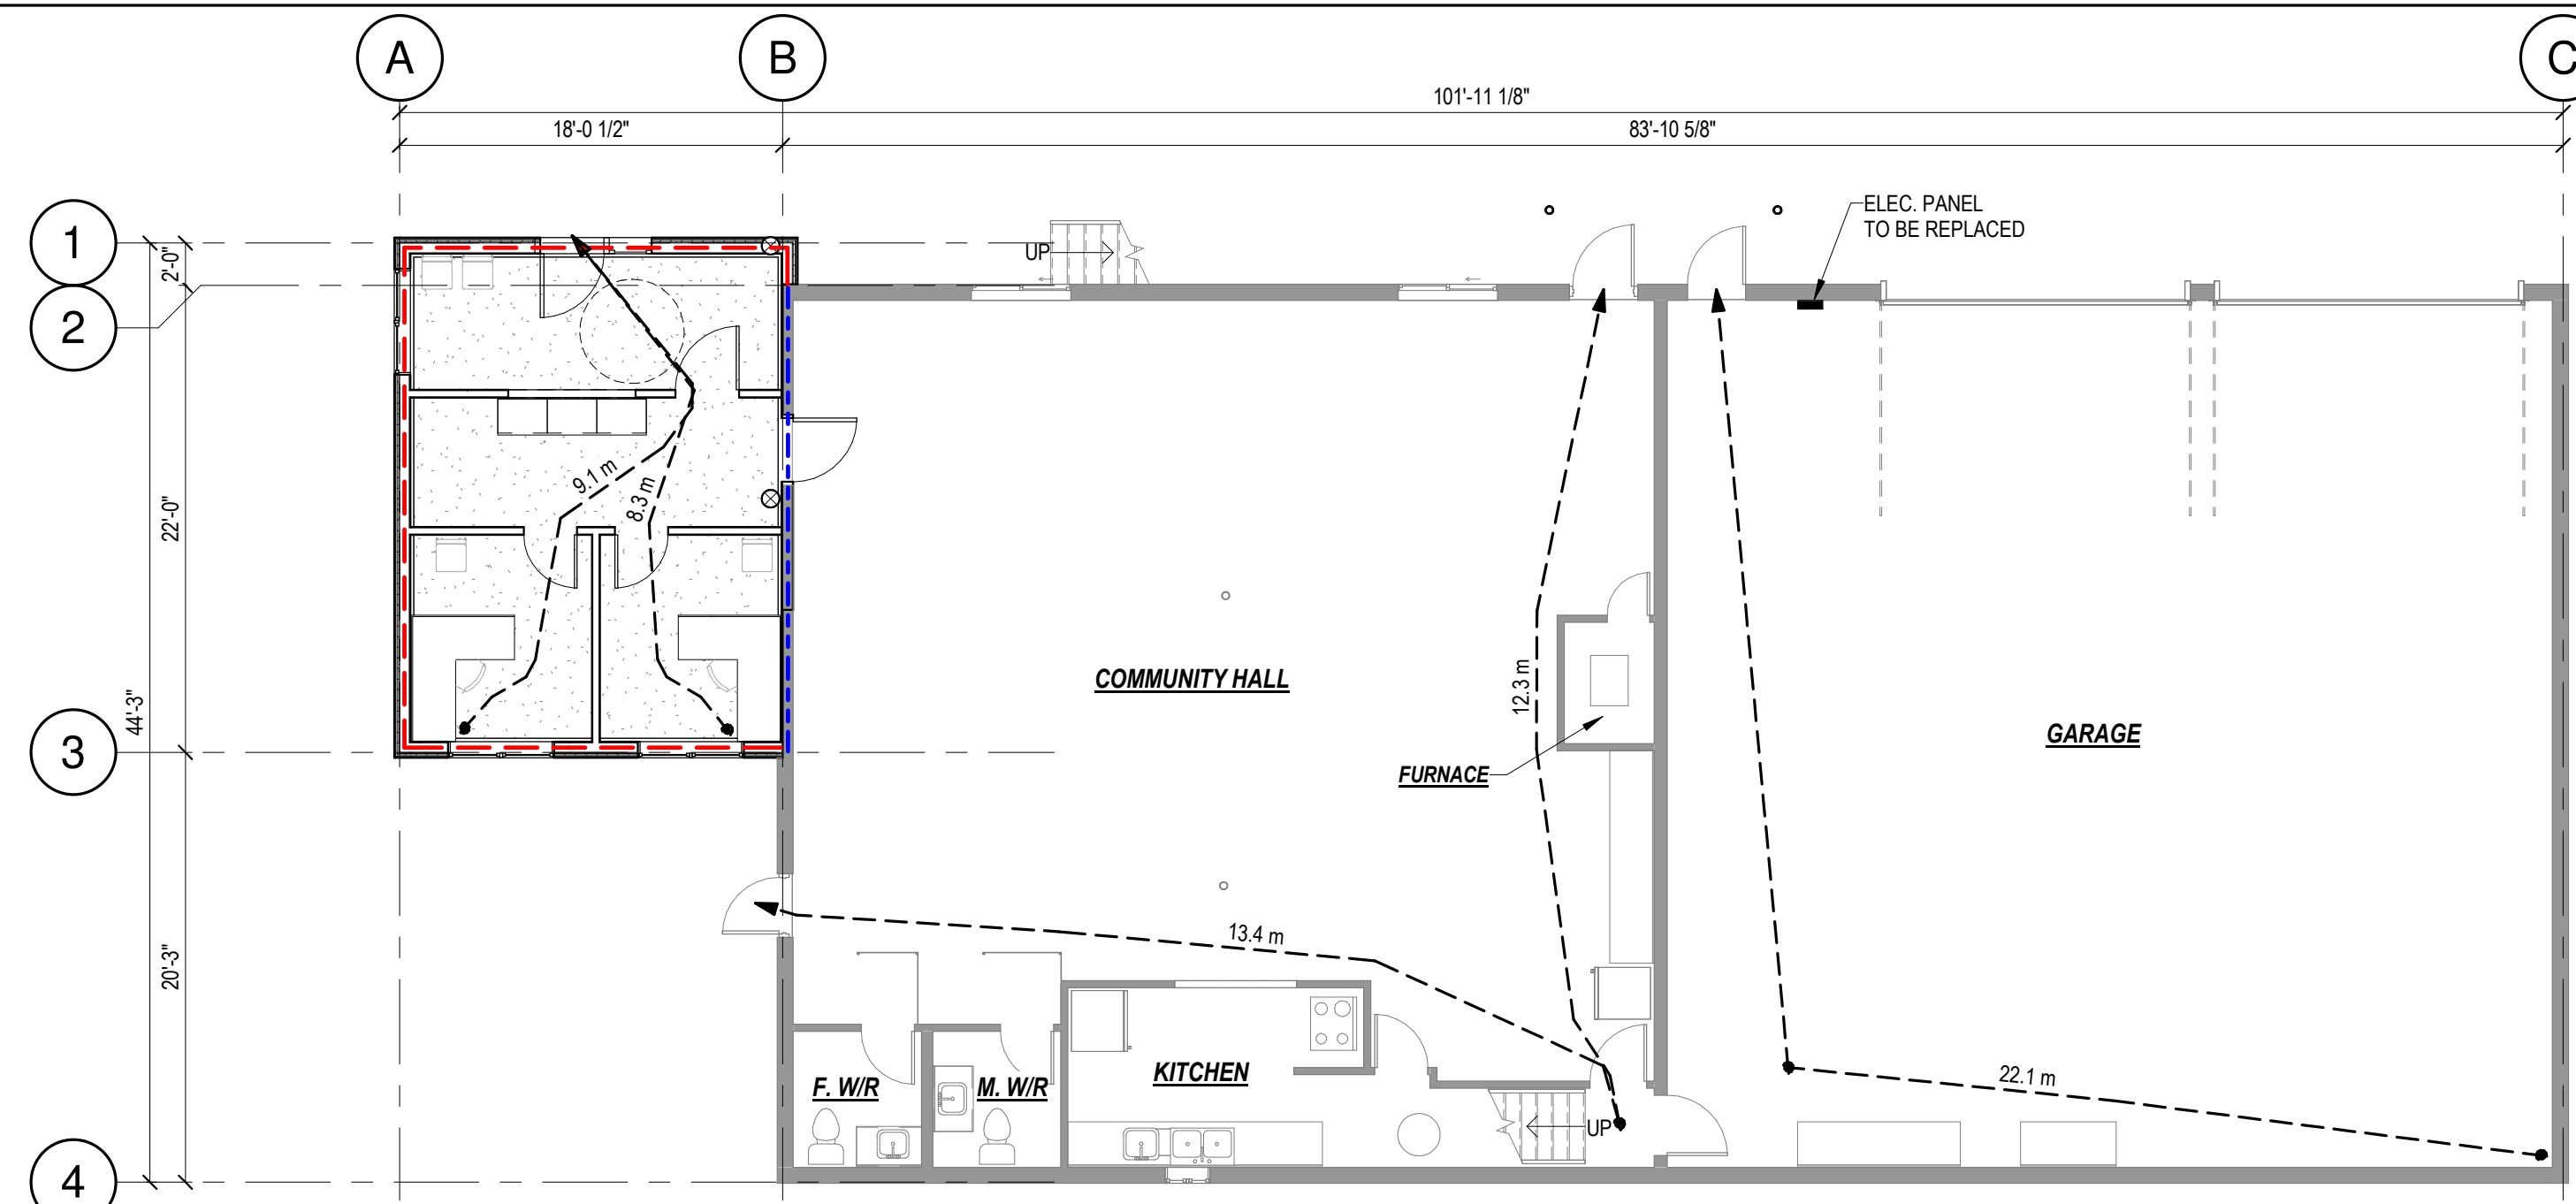

**1 GROUND FLOOR PLAN - LIFE SAFETY**  
A2 SCALE : 1/8" = 1'-0"

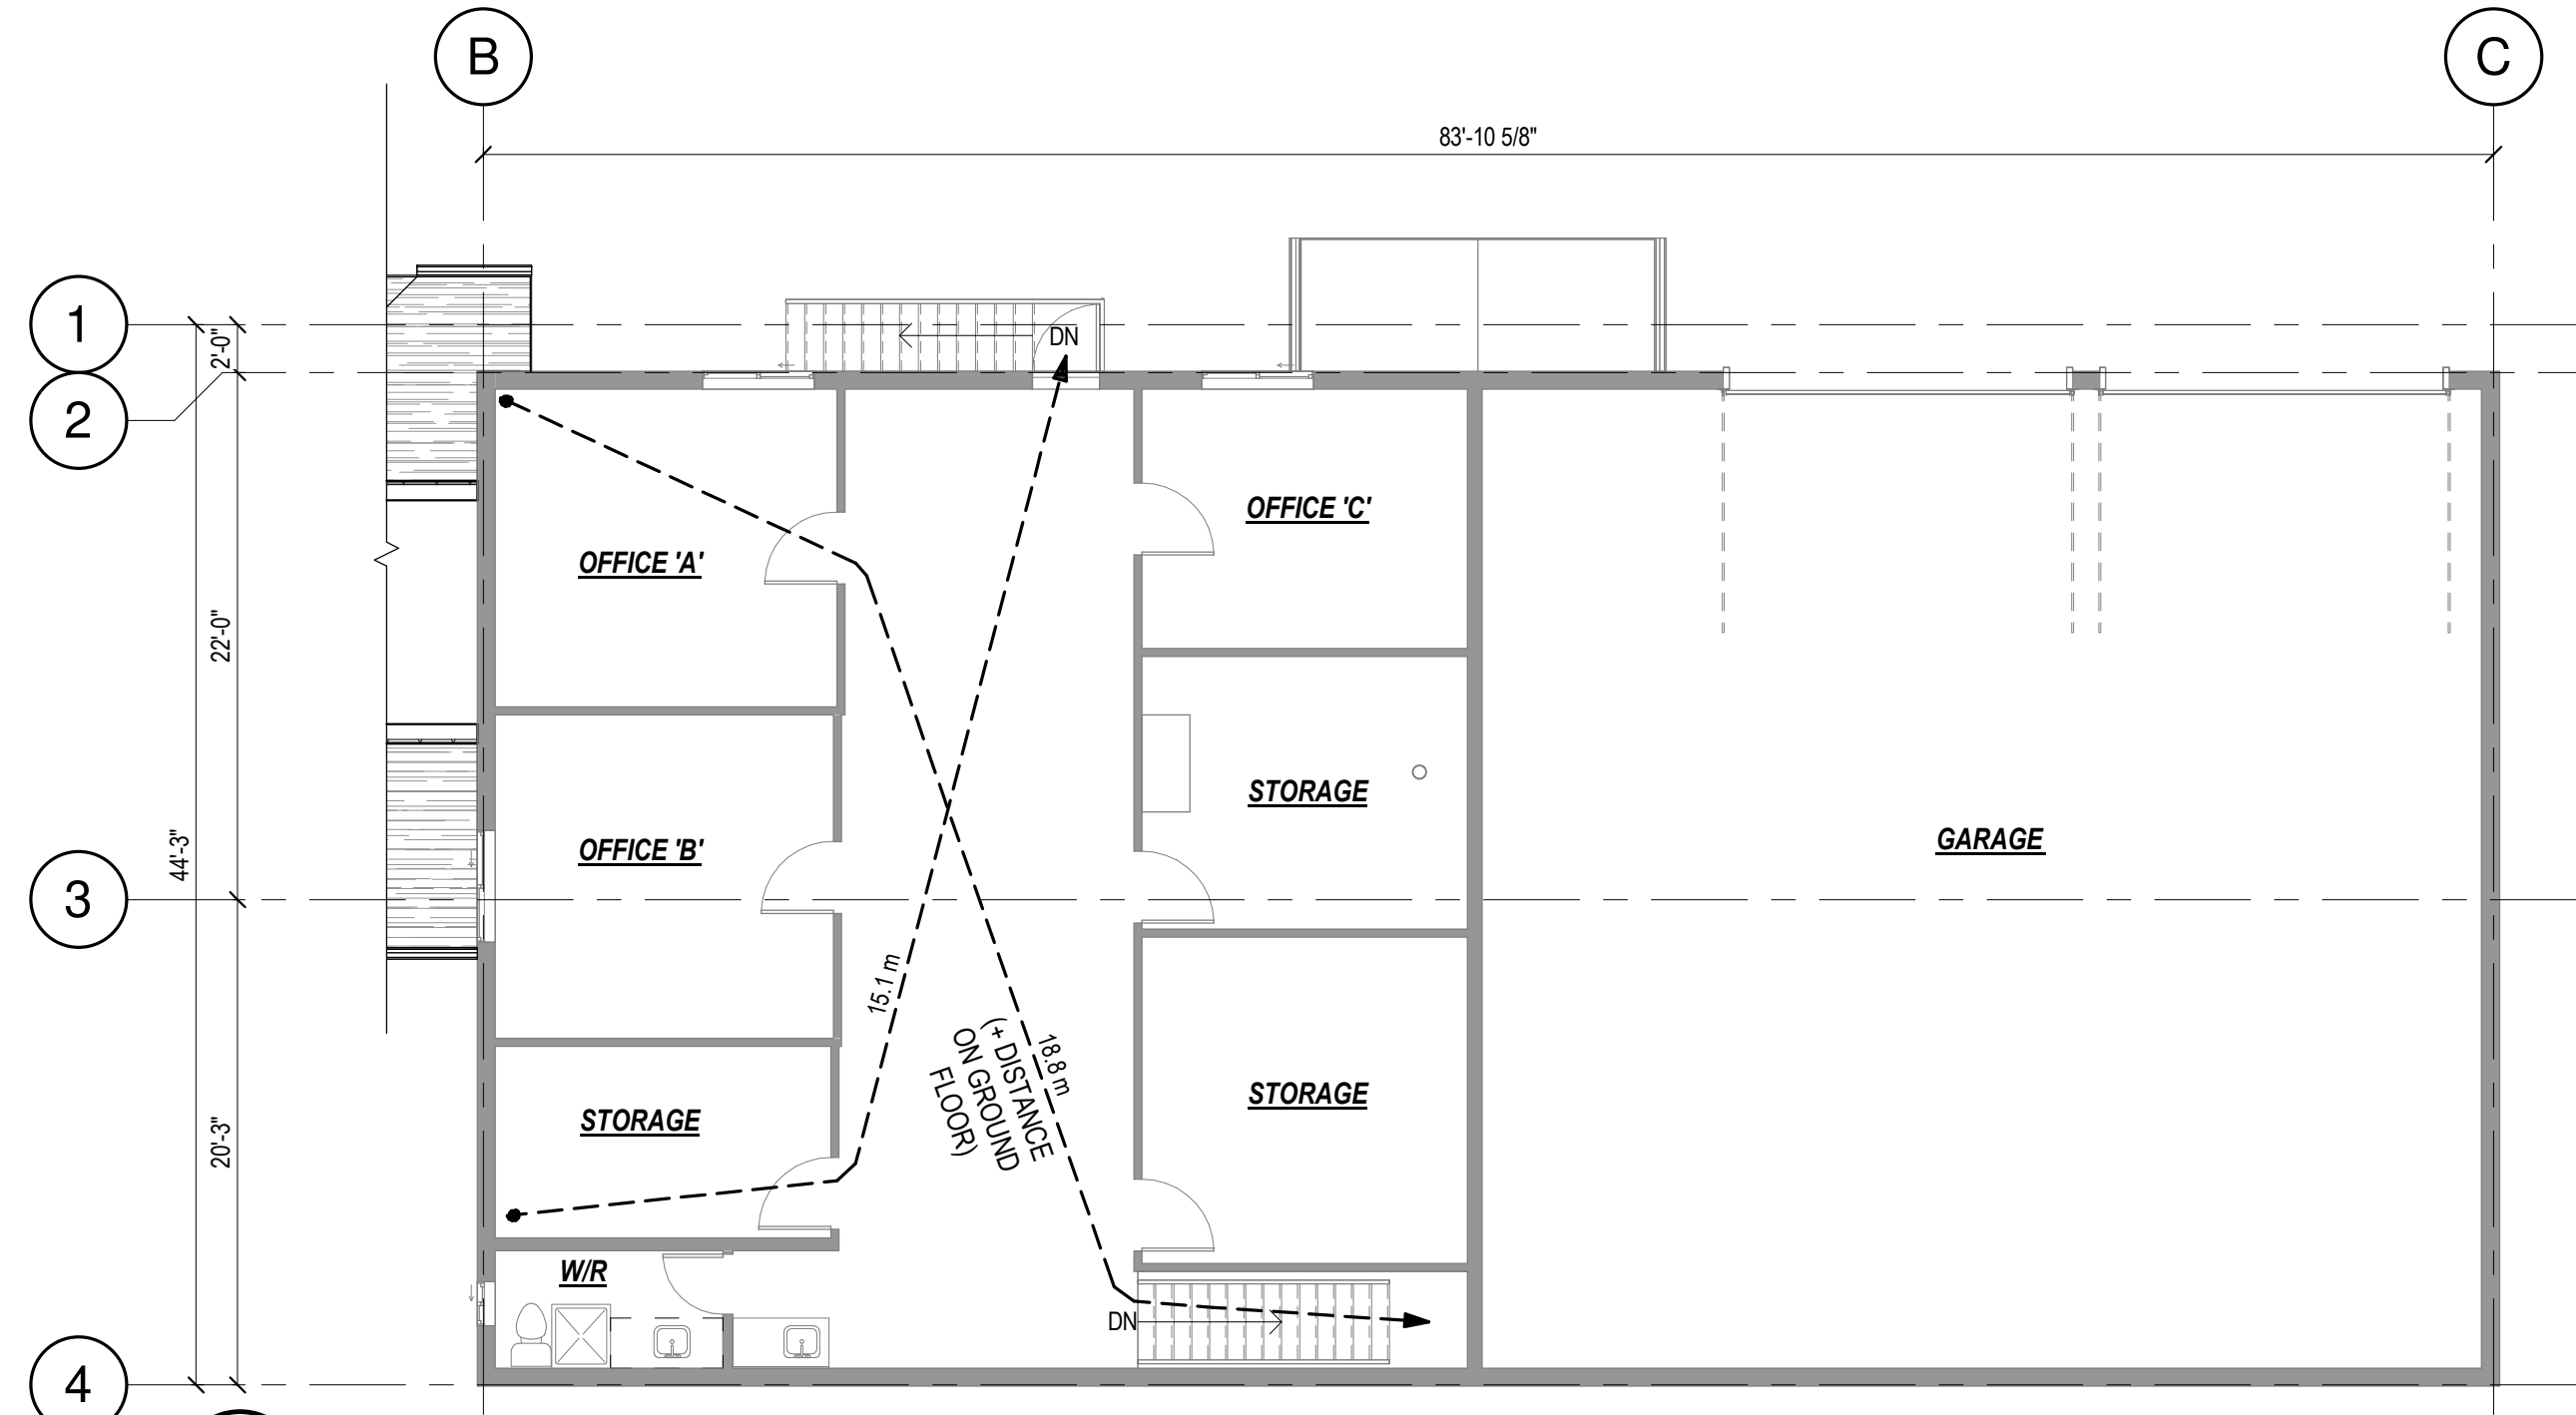

**2 SECOND FLOOR PLAN - LIFE SAFETY**  
A2 SCALE : 1/8" = 1'-0"

AREA SCHEDULE	
Addition Area	433 ft <sup>2</sup>
Existing Ground Floor Area	3562 ft <sup>2</sup>
Existing Second Floor Area	1740 ft <sup>2</sup>
<b>TOTAL AREA</b>	<b>5735 ft<sup>2</sup></b>

- FIRE / LIFE SAFETY LEGEND**
- FRR = 45 min
  - FRR = 1 h
  - 0.00m EGRESS PATH WITH TRAVEL DISTANCE
  - WALL MOUNTED EXIT SIGN w/ DOUBLE HEAD EMERGENCY LIGHT COMBO
  - FIRE EXTINGUISHER SUPPLIED AND PLACED IN ACCORDANCE w/ PART 6 OF THE ONTARIO FIRE CODE
  - SMOKE AND CARBON MONOXIDE DETECTOR c/w STROBE LIGHT
  - POWER DOOR PUSH BUTTON
  - SIGN STATING "MAX. OCCUPANCY LOAD IN THIS ROOM IS 149 PEOPLE" MOUNTED ON WALL IN A VISIBLE LOCATION BESIDE OR ABOVE DOOR


- LINE TYPE LEGEND**
- ITEMS OVERHEAD
  - ITEMS BELOW
  - ITEMS IN PLAN
  - ITEMS IN SECTION

- PHASE SPECIFIC LEGEND**
- EXISTING ITEMS TO REMAIN - PLAN
  - EXISTING ITEMS TO REMAIN - SECTION
  - DEMOLITION ITEMS - PLAN
  - DEMOLITION ITEMS - SECTION
  - NEW ITEMS - PLAN
  - NEW ITEMS - SECTION



- DIMENSIONS NOTES:**
- A. ALL DIMENSIONS TO EXISTING ITEMS ARE APPROXIMATE.
  - B. GRID LINES ARE LOCATED AT THE EXTERIOR FACE OF THE NEW EXTERIOR WALL STUD FRAMING AND THE EXTERIOR FINISH FACE OF EXISTING EXTERIOR WALLS.
  - C. WALL/PARTITION DIMENSIONS ARE MEASURED TO THE FACES OF NEW WALL FRAMING AND FINISH FACES OF EXISTING WALLS.
  - D. OPENING DIMENSIONS ARE MEASURED TO THE CENTER OF NEW WINDOW/DOOR.
  - E. DOOR ROUGH OPENINGS THAT ARE NOT DIMENSIONED SHALL BE LOCATED AT 4" FROM NEAREST FACE OF STUD FRAMING (or) SHALL BE CENTERED IN THE HALLWAY, CORRIDOR OR ROOM THAT IT SERVES.

DATE STAMP: 2023-07-26 11:29:13 AM FILE PATH: D:\RIVARC\_Sharing\Projects\22013 Hilliard Town Office Addition\Working\Modell\22013\_HilliardTwp\_OfficeAddition\_Model.rvt

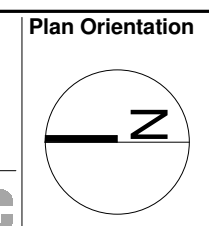

Rev.	Description	Date
1	Issued for Tender	23.07.26



**Drawing Title**  
**LIFE SAFETY PLAN**

**Project Title**  
HILLIARD TOWNSHIP OFFICE ADDITION - PHASE 1  
951678 Hwy 569, Hilliardton, ON, P0J 1L0

**Professional Stamp**  
\*I REVIEWED THIS DOCUMENT AND TAKE RESPONSIBILITY FOR THIS DESIGN. I AM QUALIFIED, AND THE FIRM IS REGISTERED, IN THE APPROPRIATE CLASSIFICATION AS PER SUBSECTION 3.2.4 OF DIVISION C OF THE BUILDING CODE.\*


**RIVARC** Sean Rivard  
BCIN # 110013 BCIN # 102394

*Sean Rivard*  
SIGNATURE

Scale	As indicated	Project No.	22013
Sheet Size	18 x 24"	Date	23.07.26
Revision	1	Drawing No.	A2
Drawn By	SWR		



DATE STAMP: 2023-07-26 11:29:13 AM FILE PATH: D:\RIVARC\_Shared\Projects\2013 Hilliard Town Office Addition\Working\Model\22013\_HilliardTwp\_OfficeAddition\_Model.rvt

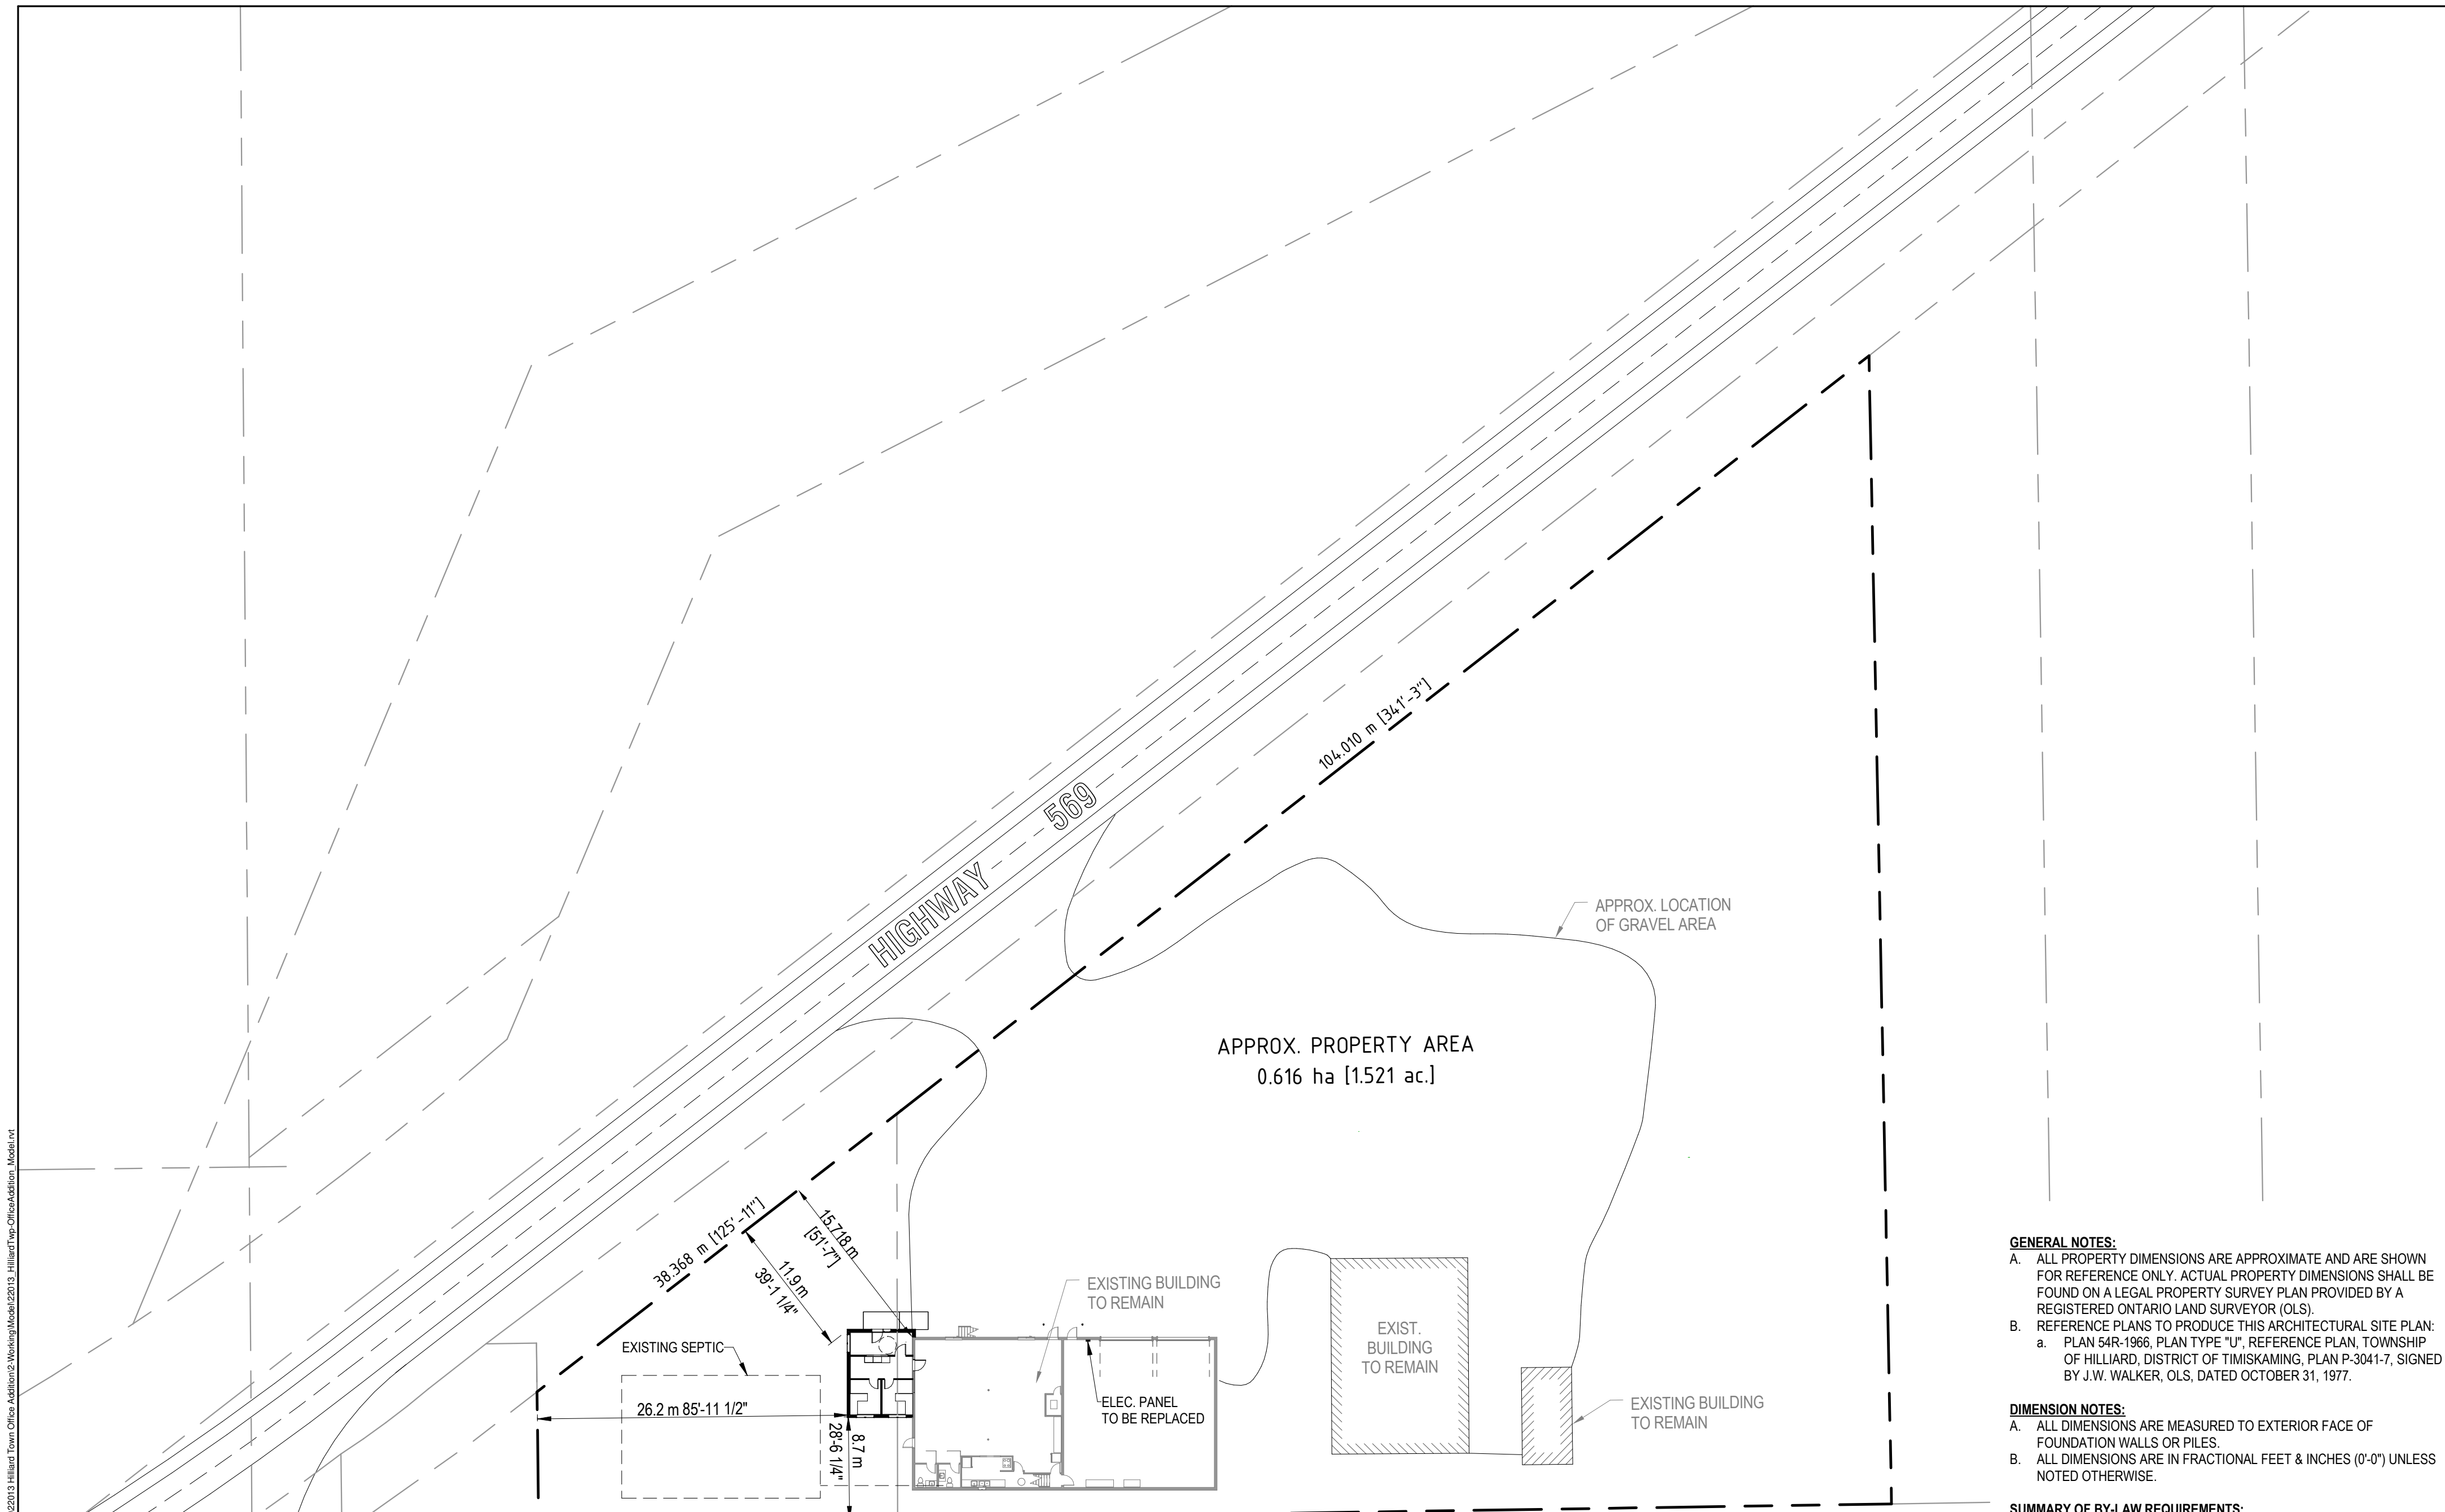

**GENERAL NOTES:**  
 A. ALL PROPERTY DIMENSIONS ARE APPROXIMATE AND ARE SHOWN FOR REFERENCE ONLY. ACTUAL PROPERTY DIMENSIONS SHALL BE FOUND ON A LEGAL PROPERTY SURVEY PLAN PROVIDED BY A REGISTERED ONTARIO LAND SURVEYOR (OLS).  
 B. REFERENCE PLANS TO PRODUCE THIS ARCHITECTURAL SITE PLAN:  
 a. PLAN 54R-1966, PLAN TYPE "U", REFERENCE PLAN, TOWNSHIP OF HILLIARD, DISTRICT OF TIMISKAMING, PLAN P-3041-7, SIGNED BY J.W. WALKER, OLS, DATED OCTOBER 31, 1977.

**DIMENSION NOTES:**  
 A. ALL DIMENSIONS ARE MEASURED TO EXTERIOR FACE OF FOUNDATION WALLS OR PILES.  
 B. ALL DIMENSIONS ARE IN FRACTIONAL FEET & INCHES (0'-0") UNLESS NOTED OTHERWISE.


**SUMMARY OF BY-LAW REQUIREMENTS:**  
 ZONING: RESIDENTIAL  
 DESIGNATION: R1 - RURAL RESIDENTIAL  
 LOT AREA: AS INDICATED

	REQUIRED	PROVIDED
MIN. FRONT (or) EXTERIOR SIDEYARD:	7.5 m	> 7.5 m
MIN. INTERIOR SIDE YARD:	1.2 m	> 1.2 m
MIN. INTERIOR REAR YARD:	10 m	> 10 m
MAX. BUILDING HEIGHT:	10 m	< 10 m
MAX. LOT COVERAGE:	15 %	< 15 %



**rivarC**  
 — DRAFTING & DESIGN —  
 sean@rivarC.ca | 705.648.3155 | rivarC.ca

**ryancompanyarchitectinc**

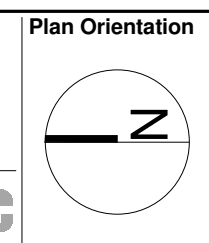

Rev.	Description	Date
1	Issued for Tender	23.07.26

Client

**Hilliard TOWNSHIP**  
 Since 1810

Drawing Title

**SITE PLAN**

Project Title

HILLIARD TOWNSHIP OFFICE ADDITION - PHASE 1  
 951678 Hwy 569, Hilliardton, ON, P0J 1L0



Professional Stamp

\*I REVIEWED THIS DOCUMENT AND TAKE RESPONSIBILITY FOR THIS DESIGN. I AM QUALIFIED, AND THE FIRM IS REGISTERED, IN THE APPROPRIATE CLASSIFICATION AS PER SUBSECTION 3.2.4 OF DIVISION C OF THE BUILDING CODE.\*

**rivarC** Sean Rivard  
 BCIN # 110013 BCIN # 102394

*Sean Rivard*  
 SIGNATURE

Scale	1" = 30'-0"	Project No.	22013
Sheet Size	18 x 24"	Date	23.07.26
Revision	1	Drawing No.	A3
Drawn By	SWR		

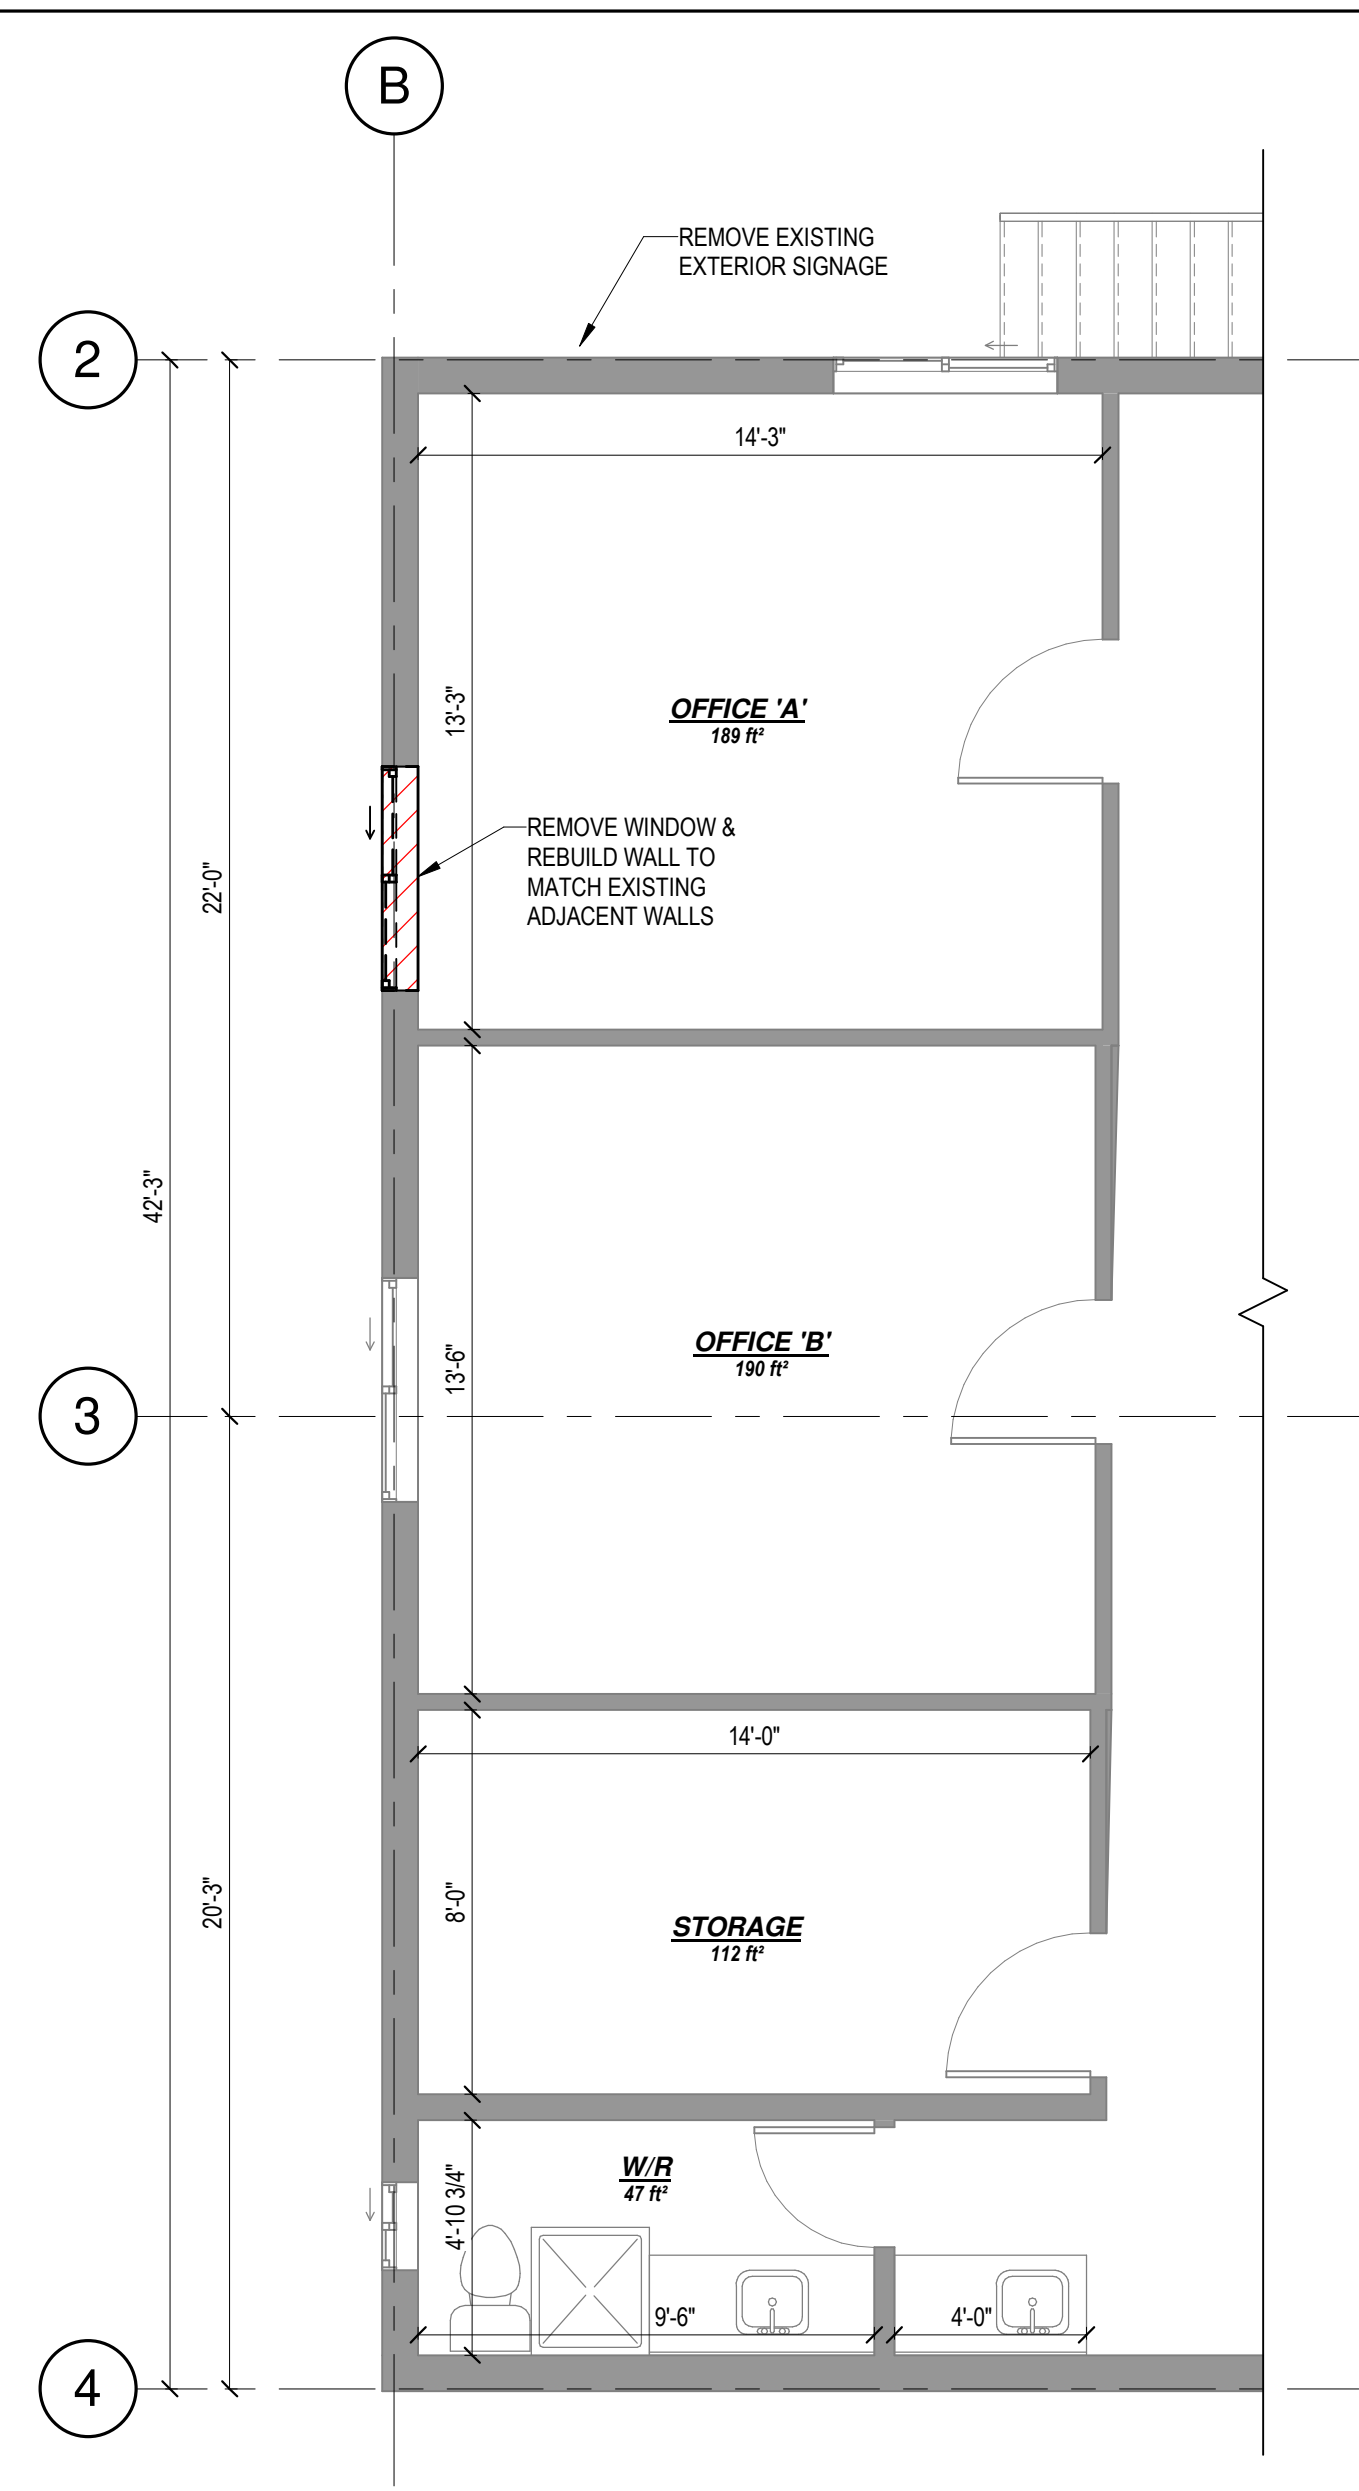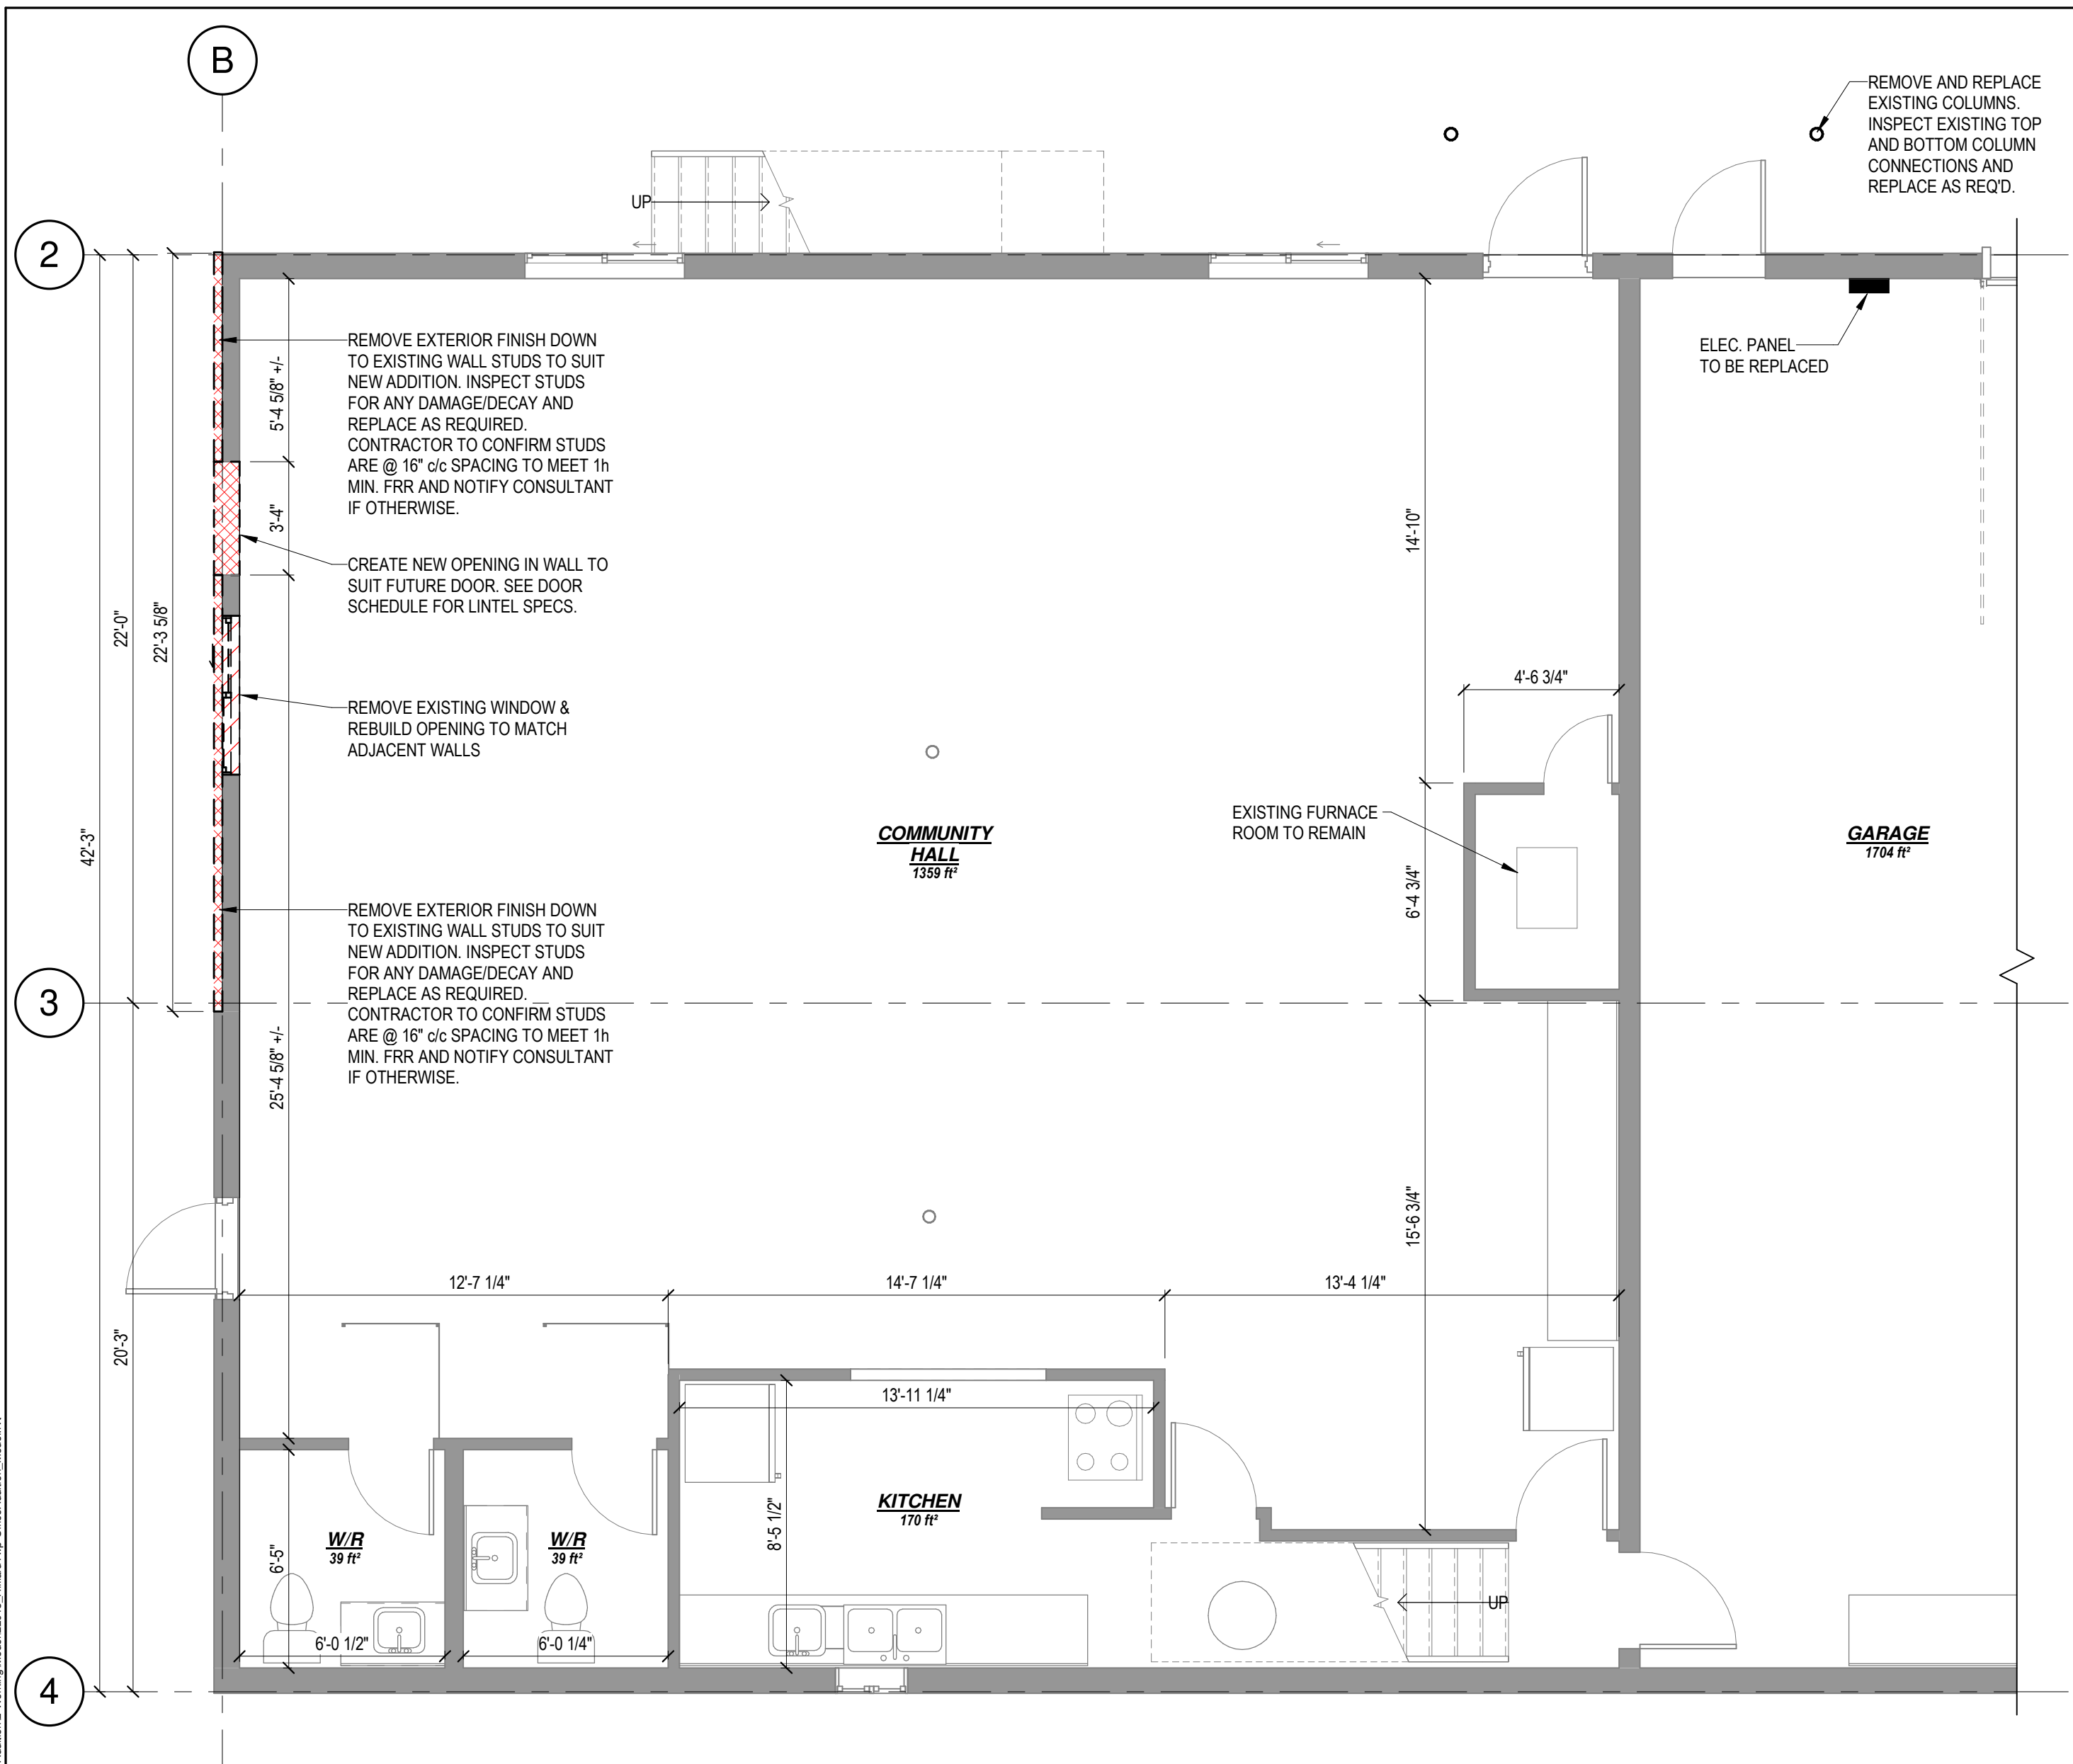

**1 GROUND FLOOR PLAN - DEMO**

A4 SCALE : 1/4" = 1'-0"

**2 SECOND FLOOR PLAN - DEMO**

A4 SCALE : 1/4" = 1'-0"

**LINE TYPE LEGEND**

--- ITEMS OVERHEAD

--- ITEMS BELOW

— ITEMS IN PLAN

— ITEMS IN SECTION

**PHASE SPECIFIC LEGEND**

□ EXISTING ITEMS TO REMAIN - PLAN

▬ EXISTING ITEMS TO REMAIN - SECTION

▨ DEMOLITION ITEMS - PLAN

▩ DEMOLITION ITEMS - SECTION

□ NEW ITEMS - PLAN

▬ NEW ITEMS - SECTION

**DIMENSIONS NOTES:**

A. ALL DIMENSIONS TO EXISTING ITEMS ARE APPROXIMATE.

B. GRID LINES ARE LOCATED AT THE EXTERIOR FACE OF THE NEW EXTERIOR WALL STUD FRAMING AND THE EXTERIOR FINISH FACE OF EXISTING EXTERIOR WALLS.

C. WALL/PARTITION DIMENSIONS ARE MEASURED TO THE FACES OF NEW WALL FRAMING AND FINISH FACES OF EXISTING WALLS.

D. OPENING DIMENSIONS ARE MEASURED TO THE CENTER OF NEW WINDOW/DOOR.


E. DOOR ROUGH OPENINGS THAT ARE NOT DIMENSIONED SHALL BE LOCATED AT 4" FROM NEAREST FACE OF STUD FRAMING (or) SHALL BE CENTERED IN THE HALLWAY, CORRIDOR OR ROOM THAT IT SERVES.



DATE STAMP: 2023-07-26 11:29:14 AM FILE PATH: D:\RIVARC\_Shared\Projects\22013 Hilliard Town Office Addition\2 Working Models\22013\_HilliardTwp\_OfficeAddition\_Model.rvt

**rivarC**  
— DRAFTING & DESIGN —  
sean@rivarC.ca | 705.648.3155 | nvarC.ca

**ryancompanyarchitectinc**

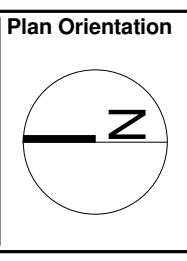

Rev.	Description	Date
1	Issued for Tender	23.07.26

**Hilliard TOWNSHIP**  
Since 1910

**DEMOLITION FLOOR PLAN**

Project Title  
HILLIARD TOWNSHIP OFFICE ADDITION - PHASE 1  
951678 Hwy 569, Hilliardton, ON, P0J 1L0

**Professional Stamp**  
"I REVIEWED THIS DOCUMENT AND TAKE RESPONSIBILITY FOR THIS DESIGN. I AM QUALIFIED, AND THE FIRM IS REGISTERED, IN THE APPROPRIATE CLASSIFICATION AS PER SUBSECTION 3.2.4 OF DIVISION C OF THE BUILDING CODE."

**rivarC**  
BCIN # 110013


**Sean Rivard**  
BCIN # 102394

*Sean Rivard*  
SIGNATURE



Scale	1/4" = 1'-0"
Sheet Size	18 x 24"
Revision	1
Drawn By	SWR

Project No.	22013
Date	23.07.26
Drawing No.	A4



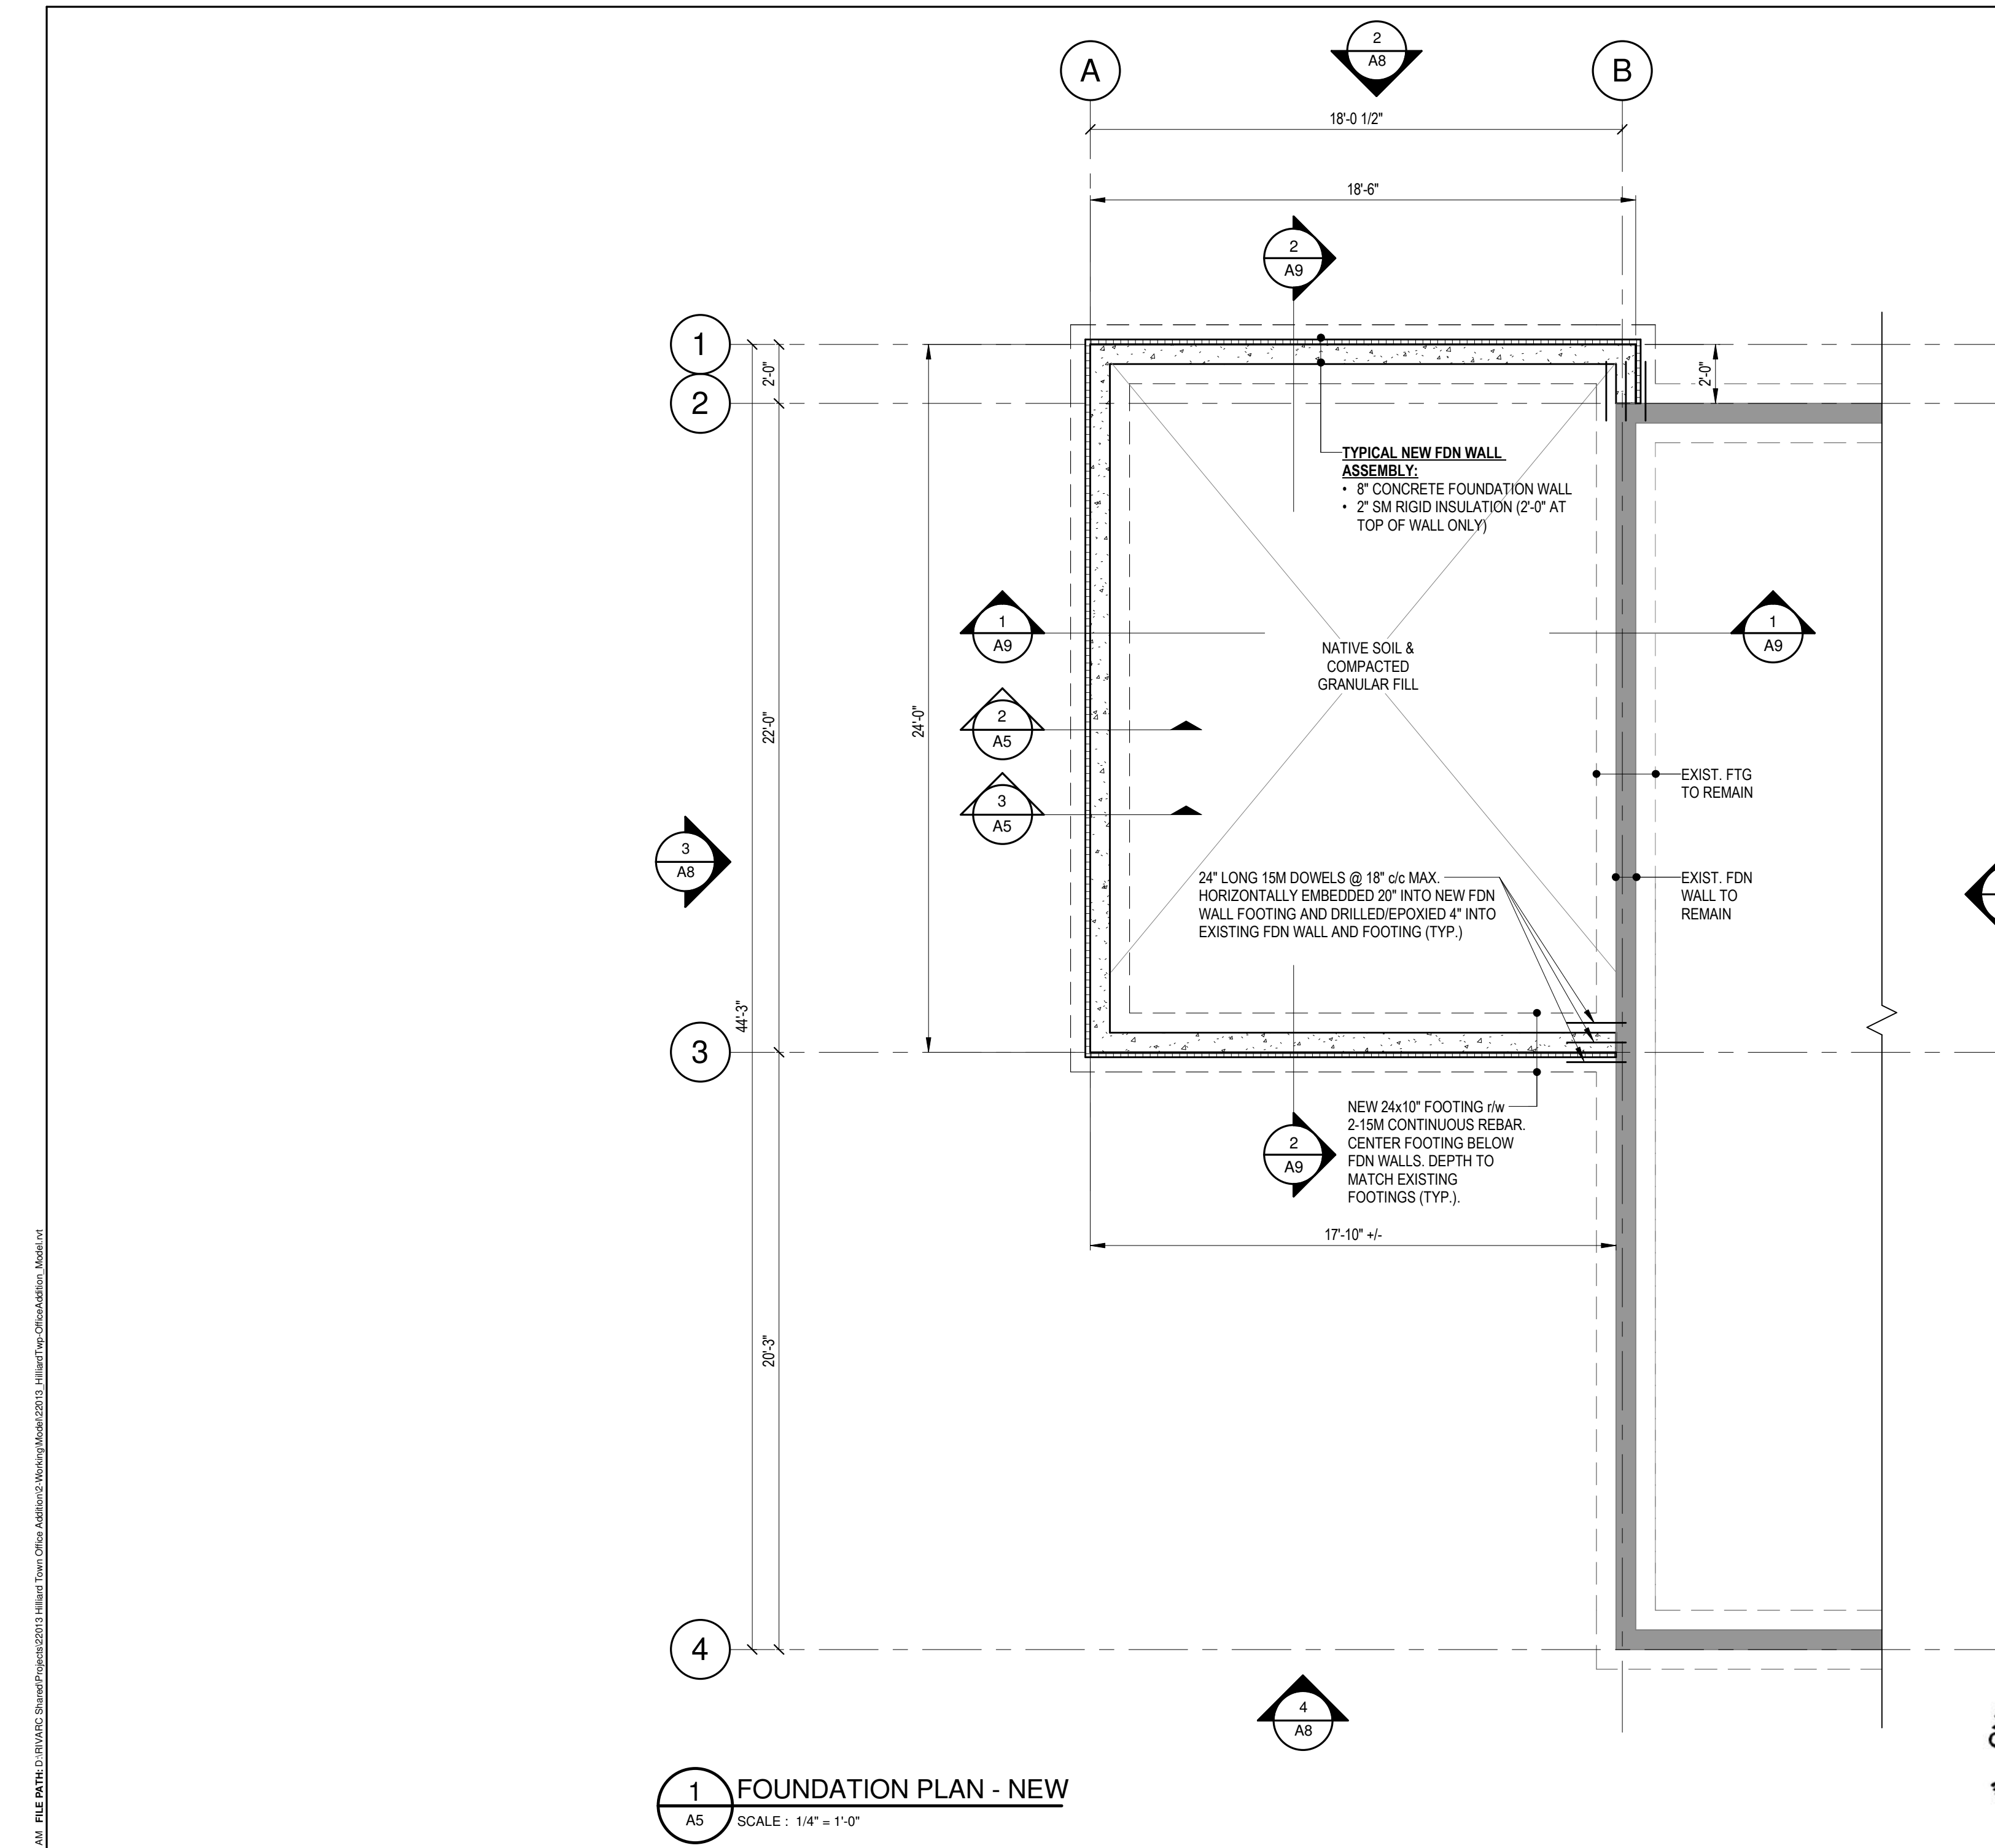

- LINE TYPE LEGEND**
- ITEMS OVERHEAD
  - ITEMS BELOW
  - ITEMS IN PLAN
  - ITEMS IN SECTION
- PHASE SPECIFIC LEGEND**
- EXISTING ITEMS TO REMAIN - PLAN
  - EXISTING ITEMS TO REMAIN - SECTION
  - ▨ DEMOLITION ITEMS - PLAN
  - ▩ DEMOLITION ITEMS - SECTION
  - NEW ITEMS - PLAN
  - NEW ITEMS - SECTION

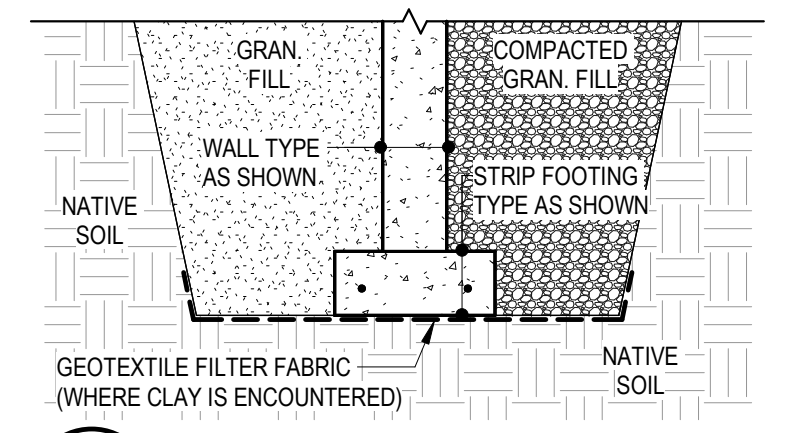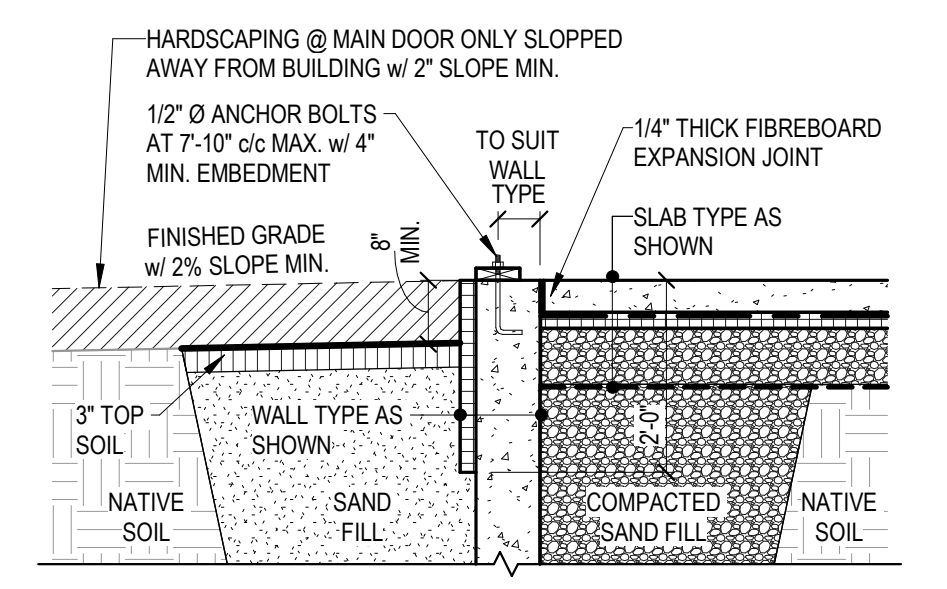


- DIMENSIONS NOTES:**
- ALL DIMENSIONS TO EXISTING ITEMS ARE APPROXIMATE.
  - GRID LINES ARE LOCATED AT THE EXTERIOR FACE OF THE NEW EXTERIOR WALL STUD FRAMING AND THE EXTERIOR FINISH FACE OF EXISTING EXTERIOR WALLS.
  - WALL/PARTITION DIMENSIONS ARE MEASURED TO THE FACES OF NEW WALL FRAMING AND FINISH FACES OF EXISTING WALLS.
  - OPENING DIMENSIONS ARE MEASURED TO THE CENTER OF NEW WINDOW/DOOR.
  - DOOR ROUGH OPENINGS THAT ARE NOT DIMENSIONED SHALL BE LOCATED AT 4" FROM NEAREST FACE OF STUD FRAMING (or) SHALL BE CENTERED IN THE HALLWAY, CORRIDOR OR ROOM THAT IT SERVES.



DATE STAMP: 2023-07-26 11:29:15 AM FILE PATH: D:\RIVARC\_Sharing\Projects\2013 Hilliard Town Office Addition\2 Working\Modell\2013\_Hilliard\Trp\_OfficeAddition\_Modell.rvt

**rivarc**  
— DRAFTING & DESIGN —  
sean@rivarc.ca | 705.648.3155 | rivarc.ca

**ryancompanyarchitectinc**

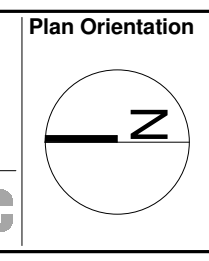


Rev.	Description	Date	Client
1	Issued for Tender	23.07.26	Hilliard Township

**Hilliard TOWNSHIP**  
Since 1810

**ADDITION FOUNDATION PLAN**

Project Title  
HILLIARD TOWNSHIP OFFICE ADDITION - PHASE 1  
951678 Hwy 569, Hilliardton, ON, P0J 1L0

Professional Stamp	Scale	Project No.
*I REVIEWED THIS DOCUMENT AND TAKE RESPONSIBILITY FOR THIS DESIGN. I AM QUALIFIED, AND THE FIRM IS REGISTERED, IN THE APPROPRIATE CLASSIFICATION AS PER SUBSECTION 3.2.4 OF DIVISION C OF THE BUILDING CODE.* <b>rivarc</b> Sean Rivard BCIN # 110013 BCIN # 102394 <i>Sean Rivard</i> SIGNATURE	As indicated	22013
	Sheet Size 18 x 24"	Date 23.07.26
	Revision 1	Drawing No. A5
	Drawn By SWR	

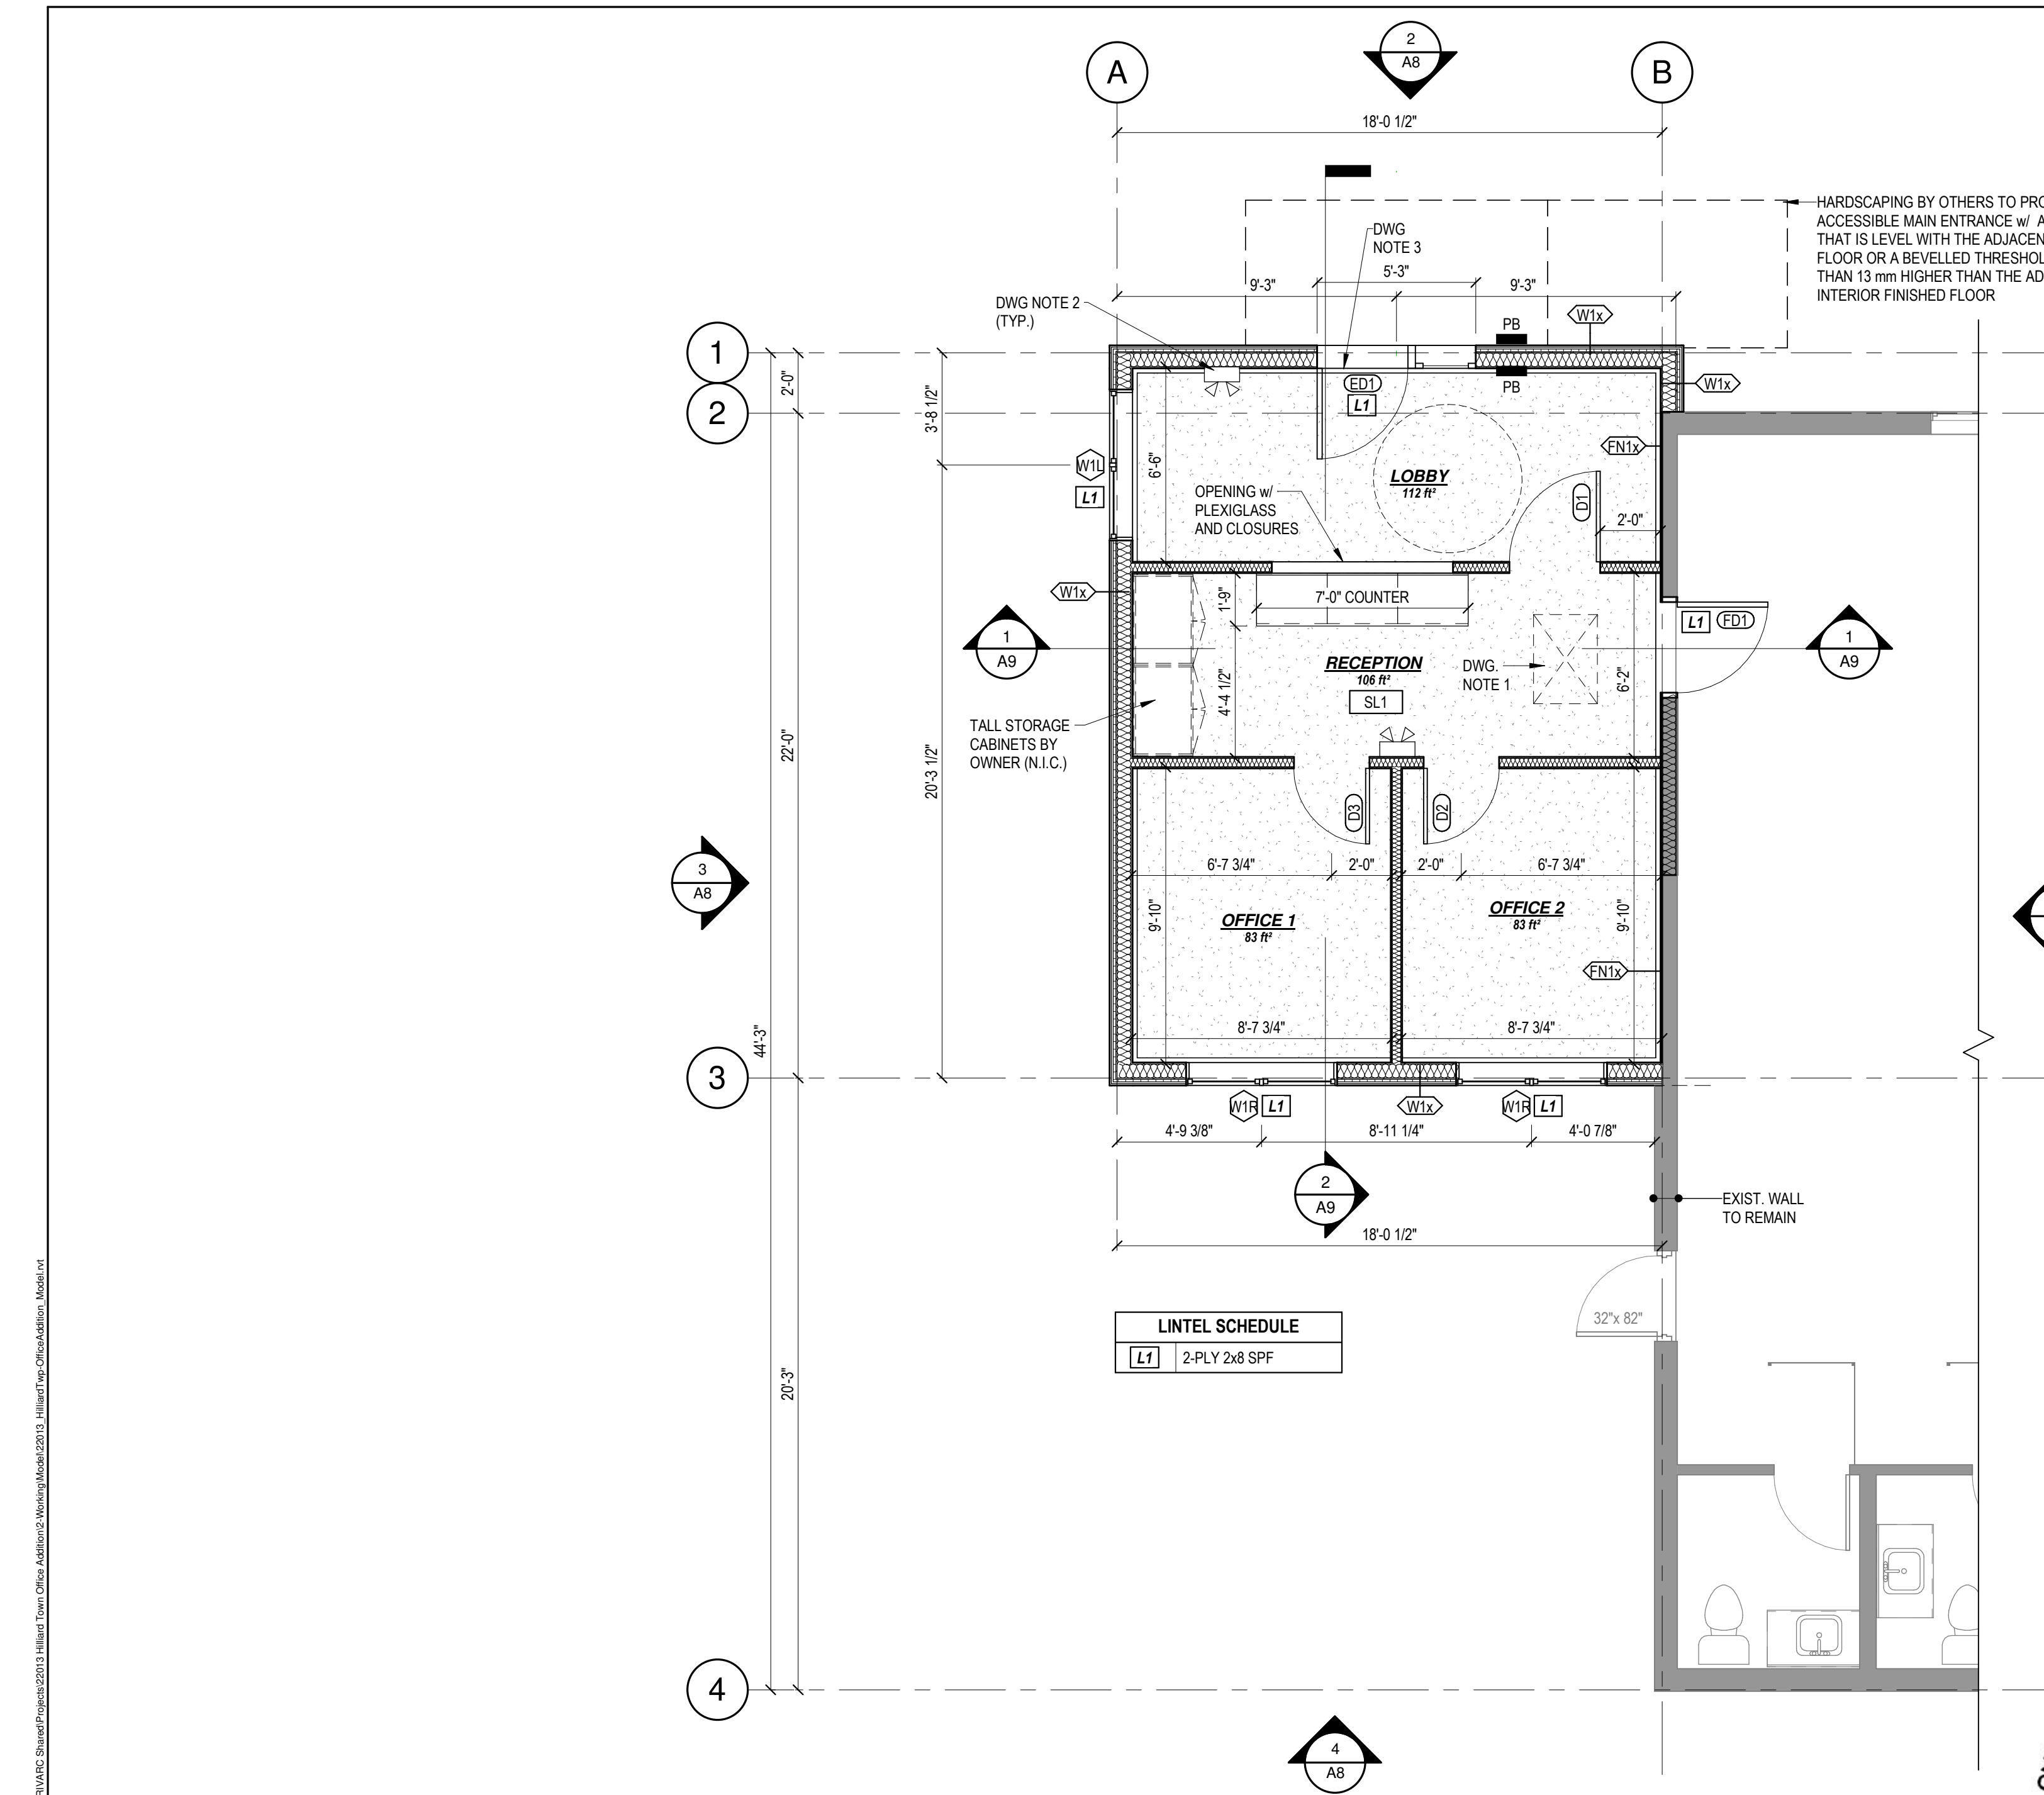

**LINE TYPE LEGEND**

- ITEMS OVERHEAD
- ITEMS BELOW
- \_\_\_\_\_ ITEMS IN PLAN
- \_\_\_\_\_ ITEMS IN SECTION

**PHASE SPECIFIC LEGEND**

- EXISTING ITEMS TO REMAIN - PLAN
- EXISTING ITEMS TO REMAIN - SECTION
- DEMOLITION ITEMS - PLAN
- DEMOLITION ITEMS - SECTION
- NEW ITEMS - PLAN
- NEW ITEMS - SECTION

HARDSCAPING BY OTHERS TO PROVIDE AN ACCESSIBLE MAIN ENTRANCE w/ A THRESHOLD THAT IS LEVEL WITH THE ADJACENT FINISHED FLOOR OR A BEVELLED THRESHOLD NOT MORE THAN 13 mm HIGHER THAN THE ADJACENT INTERIOR FINISHED FLOOR

LINTEL SCHEDULE	
L1	2-PLY 2x8 SPF

**DIMENSIONS NOTES:**

- A. ALL DIMENSIONS TO EXISTING ITEMS ARE APPROXIMATE.
- B. **GRID LINES** ARE LOCATED AT THE EXTERIOR FACE OF THE NEW EXTERIOR WALL STUD FRAMING AND THE EXTERIOR FINISH FACE OF EXISTING EXTERIOR WALLS.
- C. **WALL/PARTITION** DIMENSIONS ARE MEASURED TO THE FACES OF NEW WALL FRAMING AND FINISH FACES OF EXISTING WALLS.
- D. **OPENING** DIMENSIONS ARE MEASURED TO THE CENTER OF NEW WINDOW/DOOR.
- E. **DOOR ROUGH OPENINGS** THAT ARE NOT DIMENSIONED SHALL BE LOCATED AT 4" FROM NEAREST FACE OF STUD FRAMING (or) SHALL BE CENTERED IN THE HALLWAY, CORRIDOR OR ROOM THAT IT SERVES.

**DRAWING NOTES:**

1. PROVIDE A 550x900 mm (MIN.) ACCESS HATCH TO ATTIC SPACE ABOVE AS PER OBC SECTION 3.6.4.4.
2. EMERGENCY LIGHTING AS PER OBC 3.2.7.3. (TYP.)
3. DOOR EQUIPPED w/ GRASPABLE LATCH-OPERATING MECHANISM OPERABLE USING A CLOSED FIST LOCATED @ 900 TO 1000 mm AFFL. LOCK SET CAPABLE OF BEING RELEASED FROM THE OUTSIDE, SELF-CLOSING DEVICE AND A POWER DOOR OPERATOR & PUSH BUTTON.
4. UNIVERSAL WASHROOM SHALL BE EQUIPPED w/ A POWER DOOR OPERATOR, AN EMERGENCY CALL FOR ASSISTANCE ALARM, GRAB BARS AND ALL OTHER OBC REQUIREMENTS IN SECTION 3.8.


**1** GROUND FLOOR PLAN - NEW ADDITION  
A6 SCALE : 1/4" = 1'-0"



DATE STAMP: 2023-07-26 11:29:15 AM FILE PATH: D:\RIVARC\_Sharing\Projects\2023\Hilliard Town Office Addition\2-Working\Model\2023\_Hilliard\Twp\_OfficeAddition\_Model.rvt

**rivarc**  
DRAFTING & DESIGN  
sean@rivarc.ca | 705.648.3155 | rivarc.ca

**ryancompanyarchitectinc**

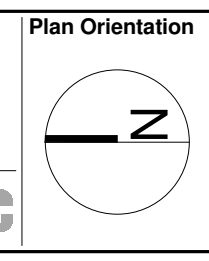

Rev.	Description	Date
1	Issued for Client Review	23.04.14
2	Issued for Tender	23.07.26

**Hilliard TOWNSHIP**  
Since 1910

**ADDITION FLOOR PLAN**

Project Title  
HILLIARD TOWNSHIP OFFICE ADDITION - PHASE 1  
951678 Hwy 569, Hilliardton, ON, P0J 1L0

**Professional Stamp**


\*I REVIEWED THIS DOCUMENT AND TAKE RESPONSIBILITY FOR THIS DESIGN. I AM QUALIFIED, AND THE FIRM IS REGISTERED, IN THE APPROPRIATE CLASSIFICATION AS PER SUBSECTION 3.2.4 OF DIVISION C OF THE BUILDING CODE.\*

**rivarc** Sean Rivard  
BCIN # 110013 BCIN # 102394

*Sean Rivard*  
SIGNATURE

Scale	As indicated
Sheet Size	18 x 24"
Revision	2
Drawn By	SWR

Project No.	22013
Date	23.07.26
Drawing No.	A6

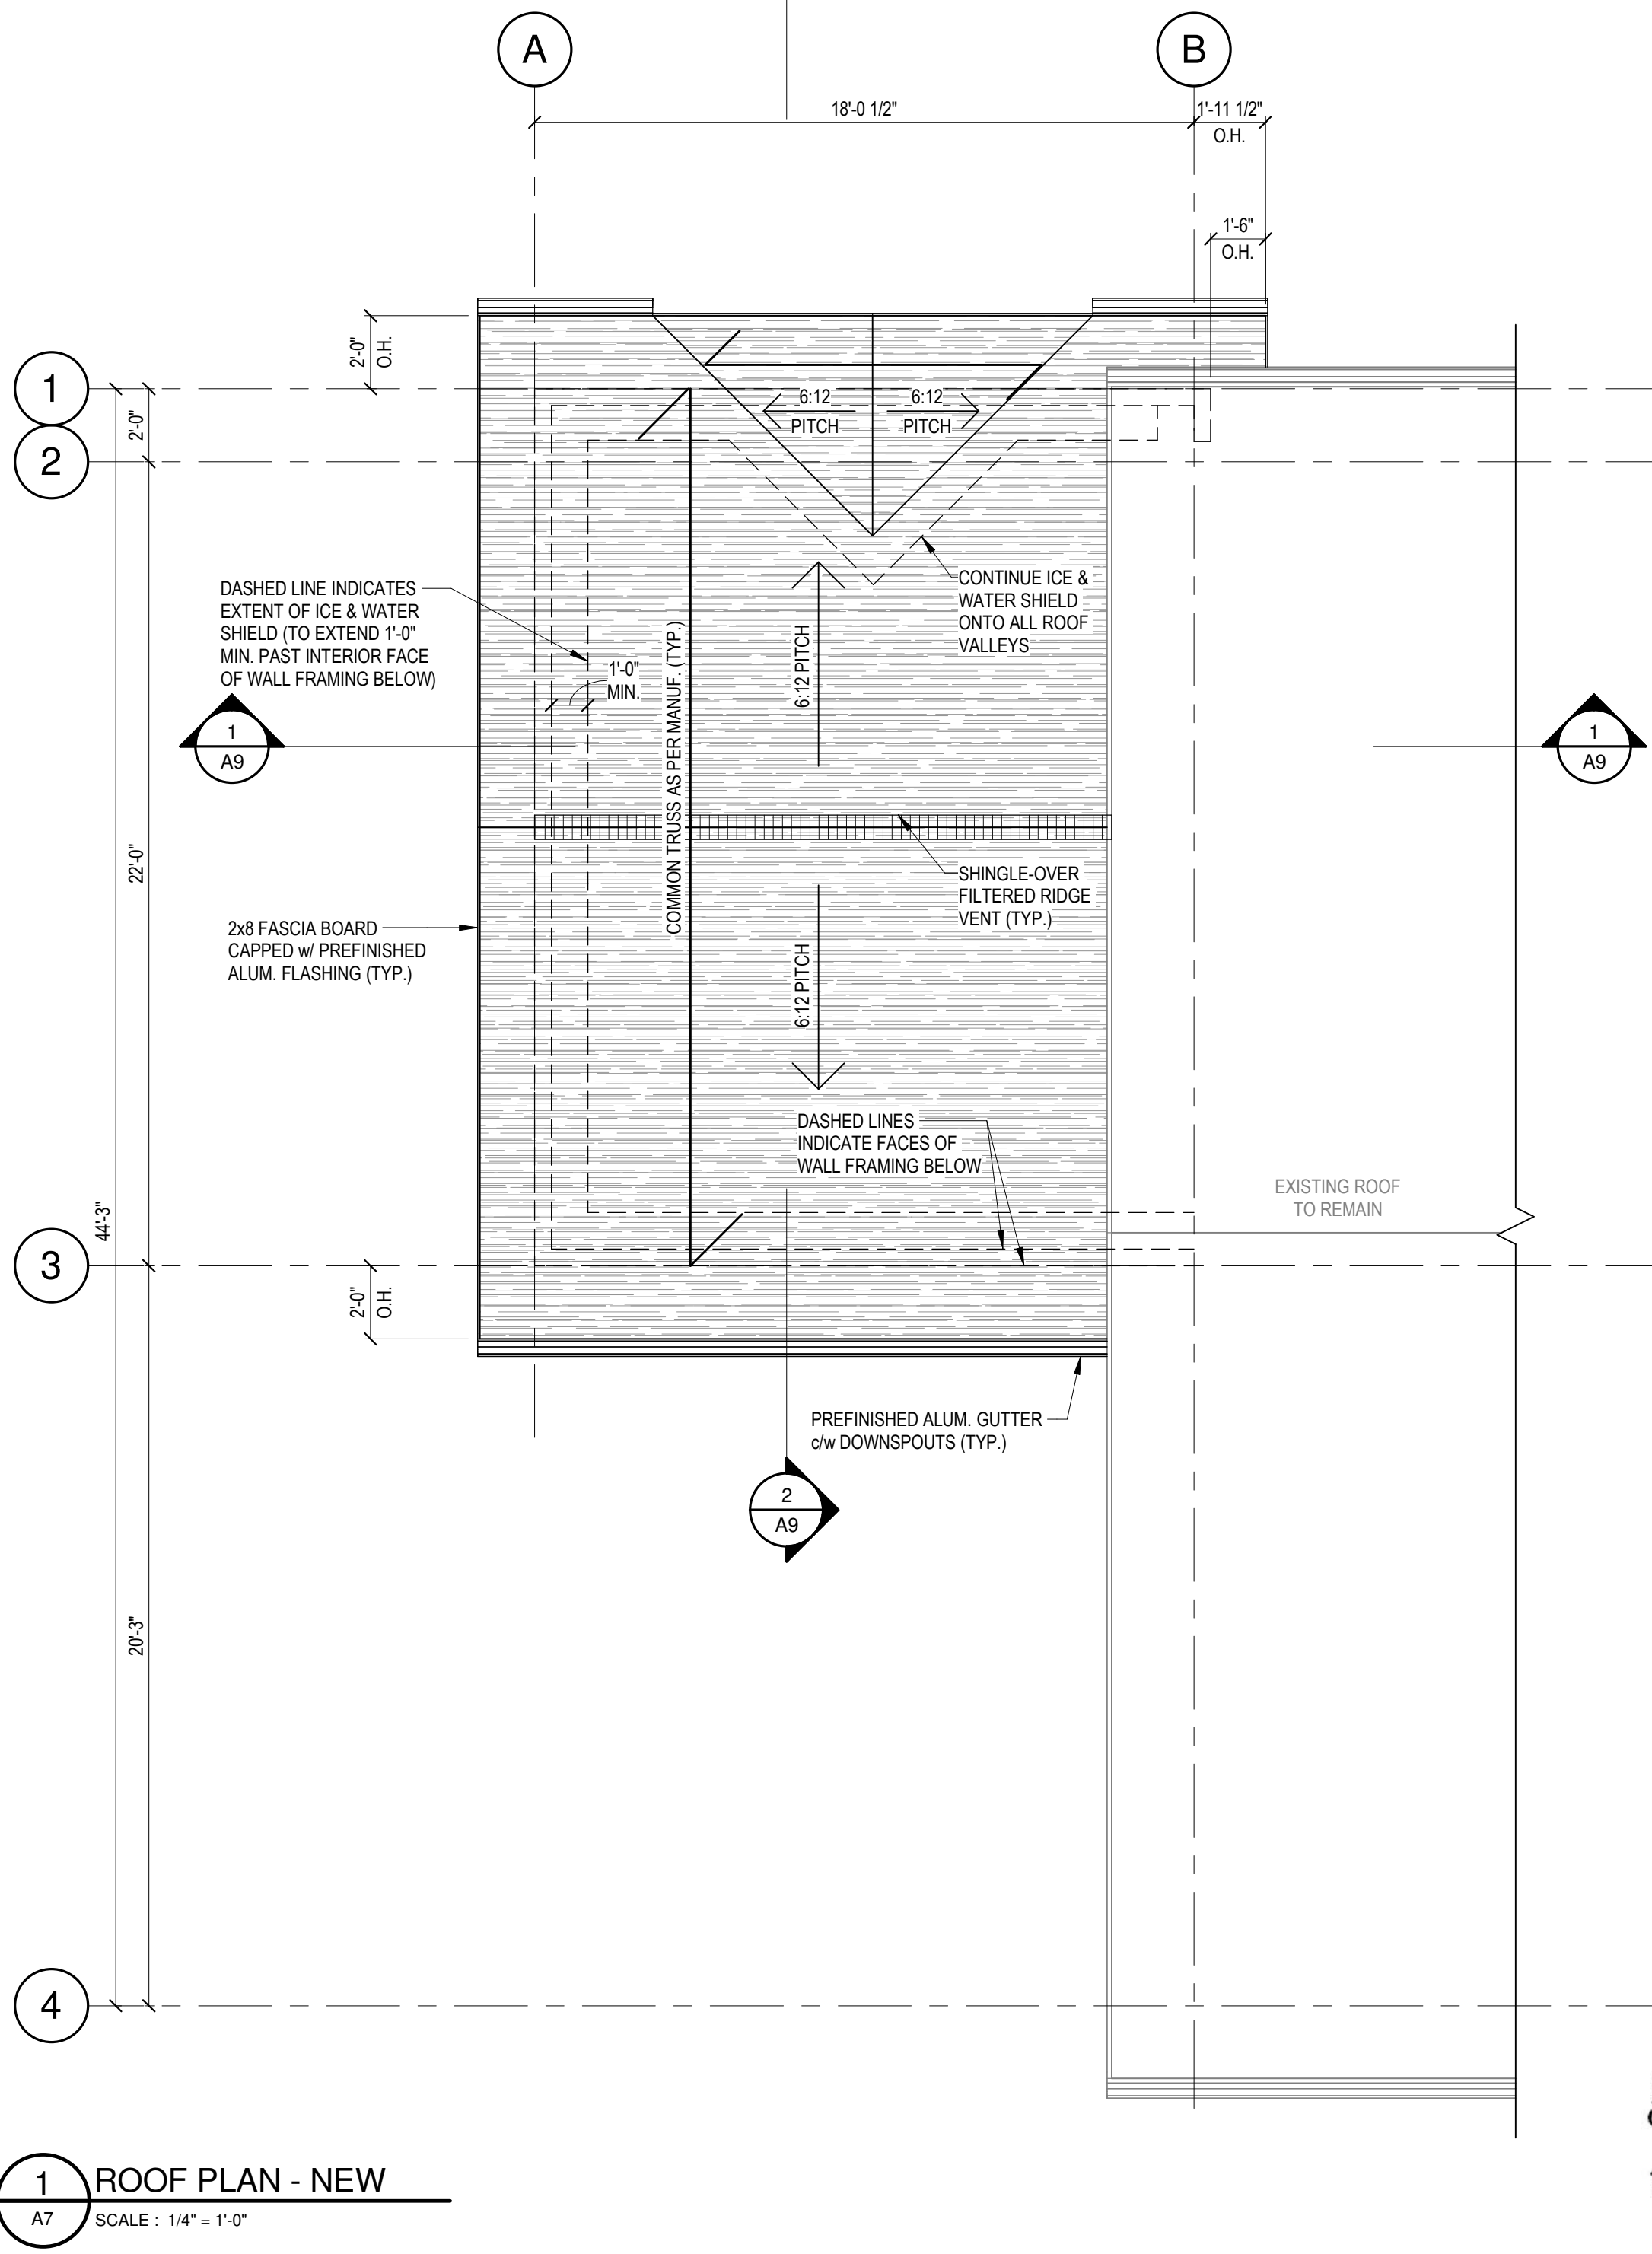

1 ROOF PLAN - NEW  
A7 SCALE : 1/4" = 1'-0"




- DIMENSIONS NOTES:**
- A. ALL DIMENSIONS TO EXISTING ITEMS ARE APPROXIMATE.
  - B. GRID LINES ARE LOCATED AT THE EXTERIOR FACE OF THE NEW EXTERIOR WALL STUD FRAMING AND THE EXTERIOR FINISH FACE OF EXISTING EXTERIOR WALLS.
  - C. ROOF DIMENSIONS ARE MEASURED TO GRID LINES, FACES OF ROOF FRAMING AND FACES OF WALL FRAMING BELOW.
  - D. OVERHANG (O.H.) DIMENSIONS ARE MEASURED TO FACES OF ROOF FRAMING AND EXTERIOR FACE OF WALL FRAMING OR COLUMN BELOW.

DATE STAMP: 2023-07-26 11:29:16 AM FILE PATH: D:\RIVARC\_Sharing\Projects\22013 Hilliard Town Office Addition\2 Working\Mode\22013\_Hilliard\Trp\_OfficeAddition\_Mode.rvt



ryancompanyarchitectinc

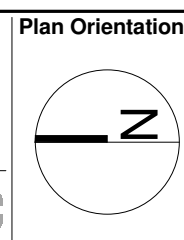

Rev. Description  
1 Issued for Tender

Date  
23.07.26



Drawing Title  
**ADDITION ROOF PLAN**


Project Title  
HILLIARD TOWNSHIP OFFICE ADDITION - PHASE 1  
951678 Hwy 569, Hilliardton, ON, P0J 1L0

Professional Stamp  
\*I REVIEWED THIS DOCUMENT AND TAKE RESPONSIBILITY FOR THIS DESIGN. I AM QUALIFIED, AND THE FIRM IS REGISTERED, IN THE APPROPRIATE CLASSIFICATION AS PER SUBSECTION 3.2.4 OF DIVISION C OF THE BUILDING CODE.\*  
RIVARC Sean Rivard  
BCIN # 110013 BCIN # 102394  
*Sean Rivard*  
SIGNATURE


Scale 1/4" = 1'-0"  
Sheet Size 18 x 24"  
Revision 1  
Drawn By SWR

Project No. 22013  
Date 23.07.26  
Drawing No. **A7**




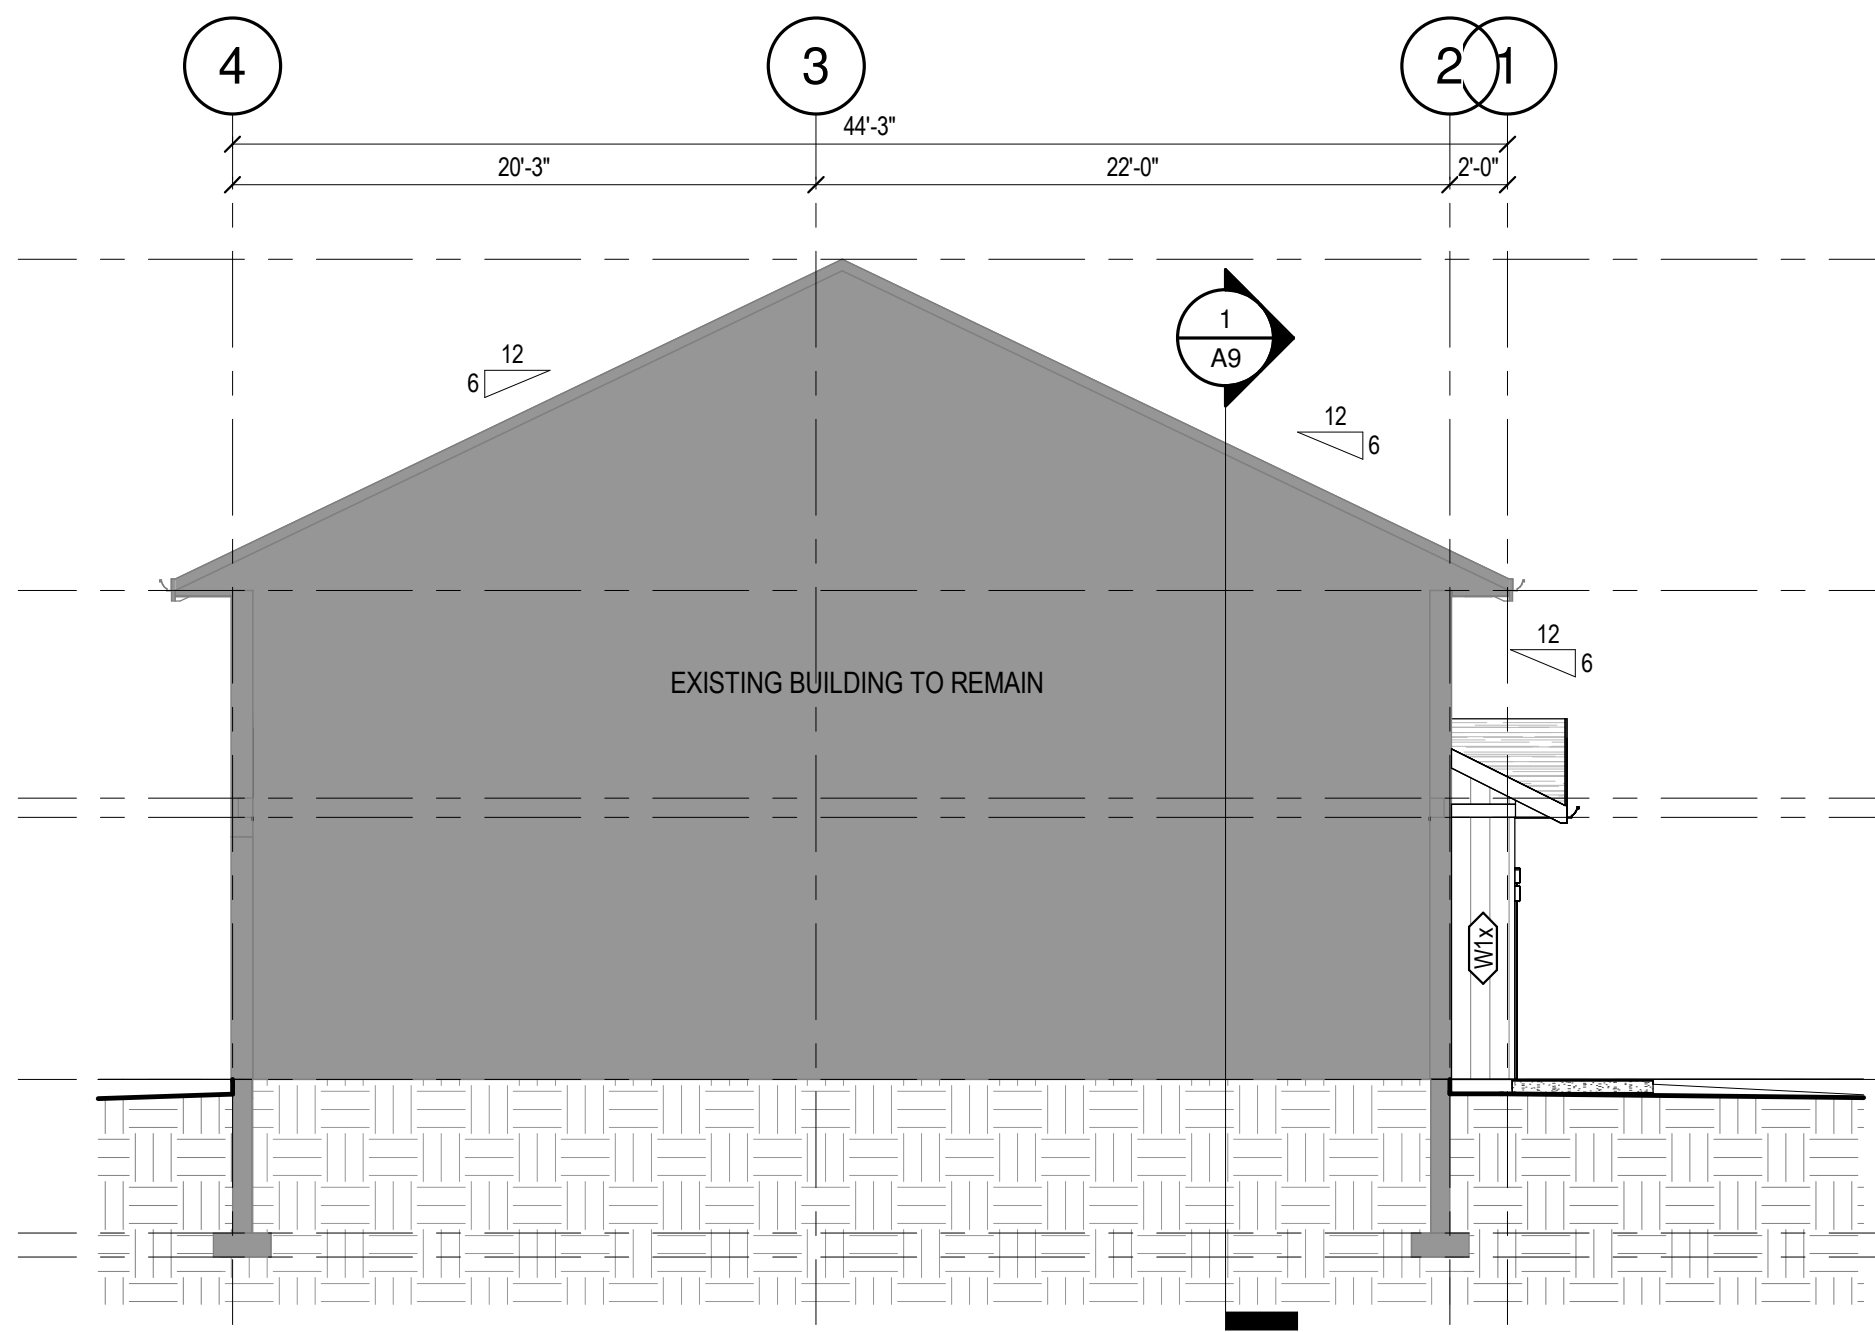


**1 SOUTH ELEVATION - NEW**  
A8 SCALE : 1 : 80

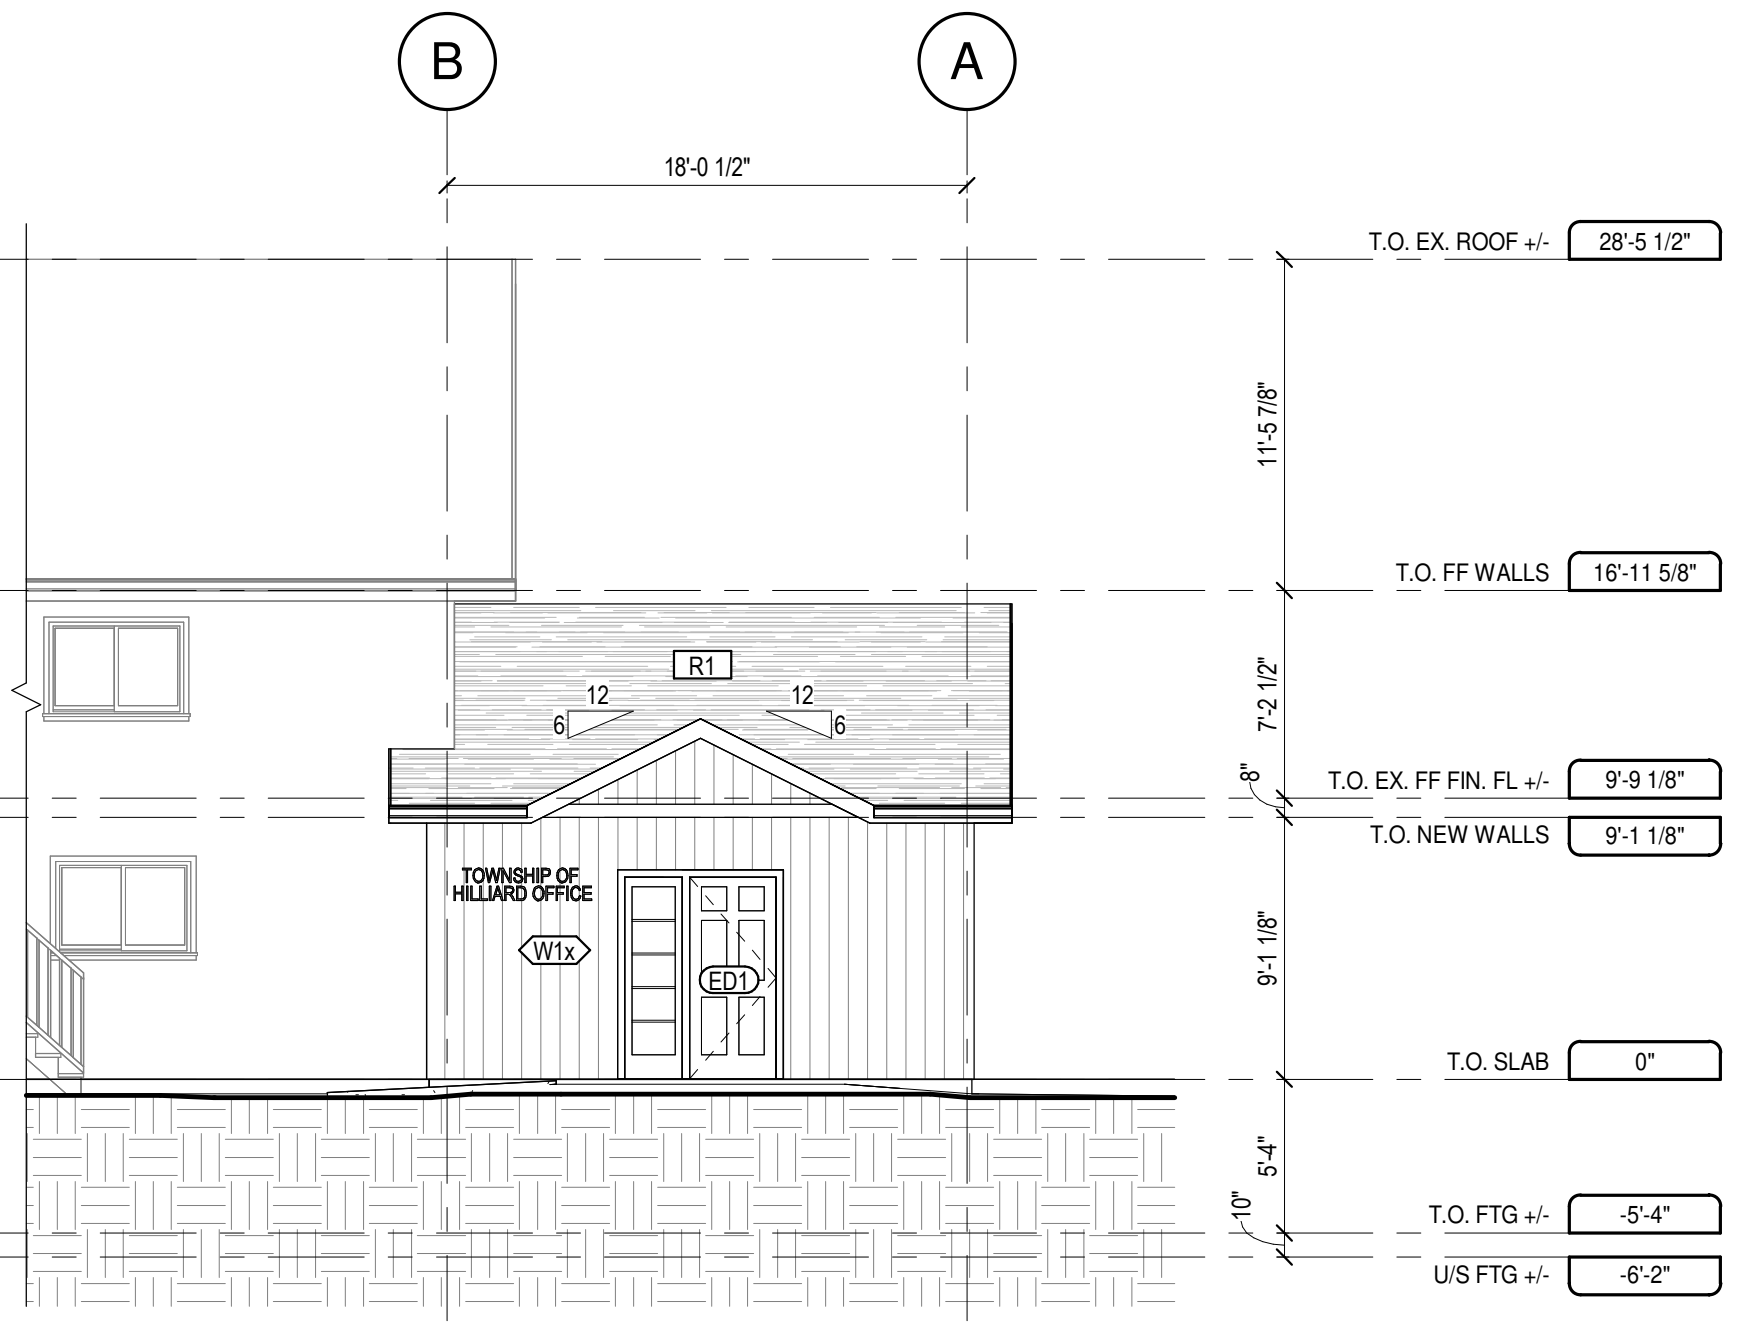

**2 EAST ELEVATION - NEW**  
A8 SCALE : 1 : 80

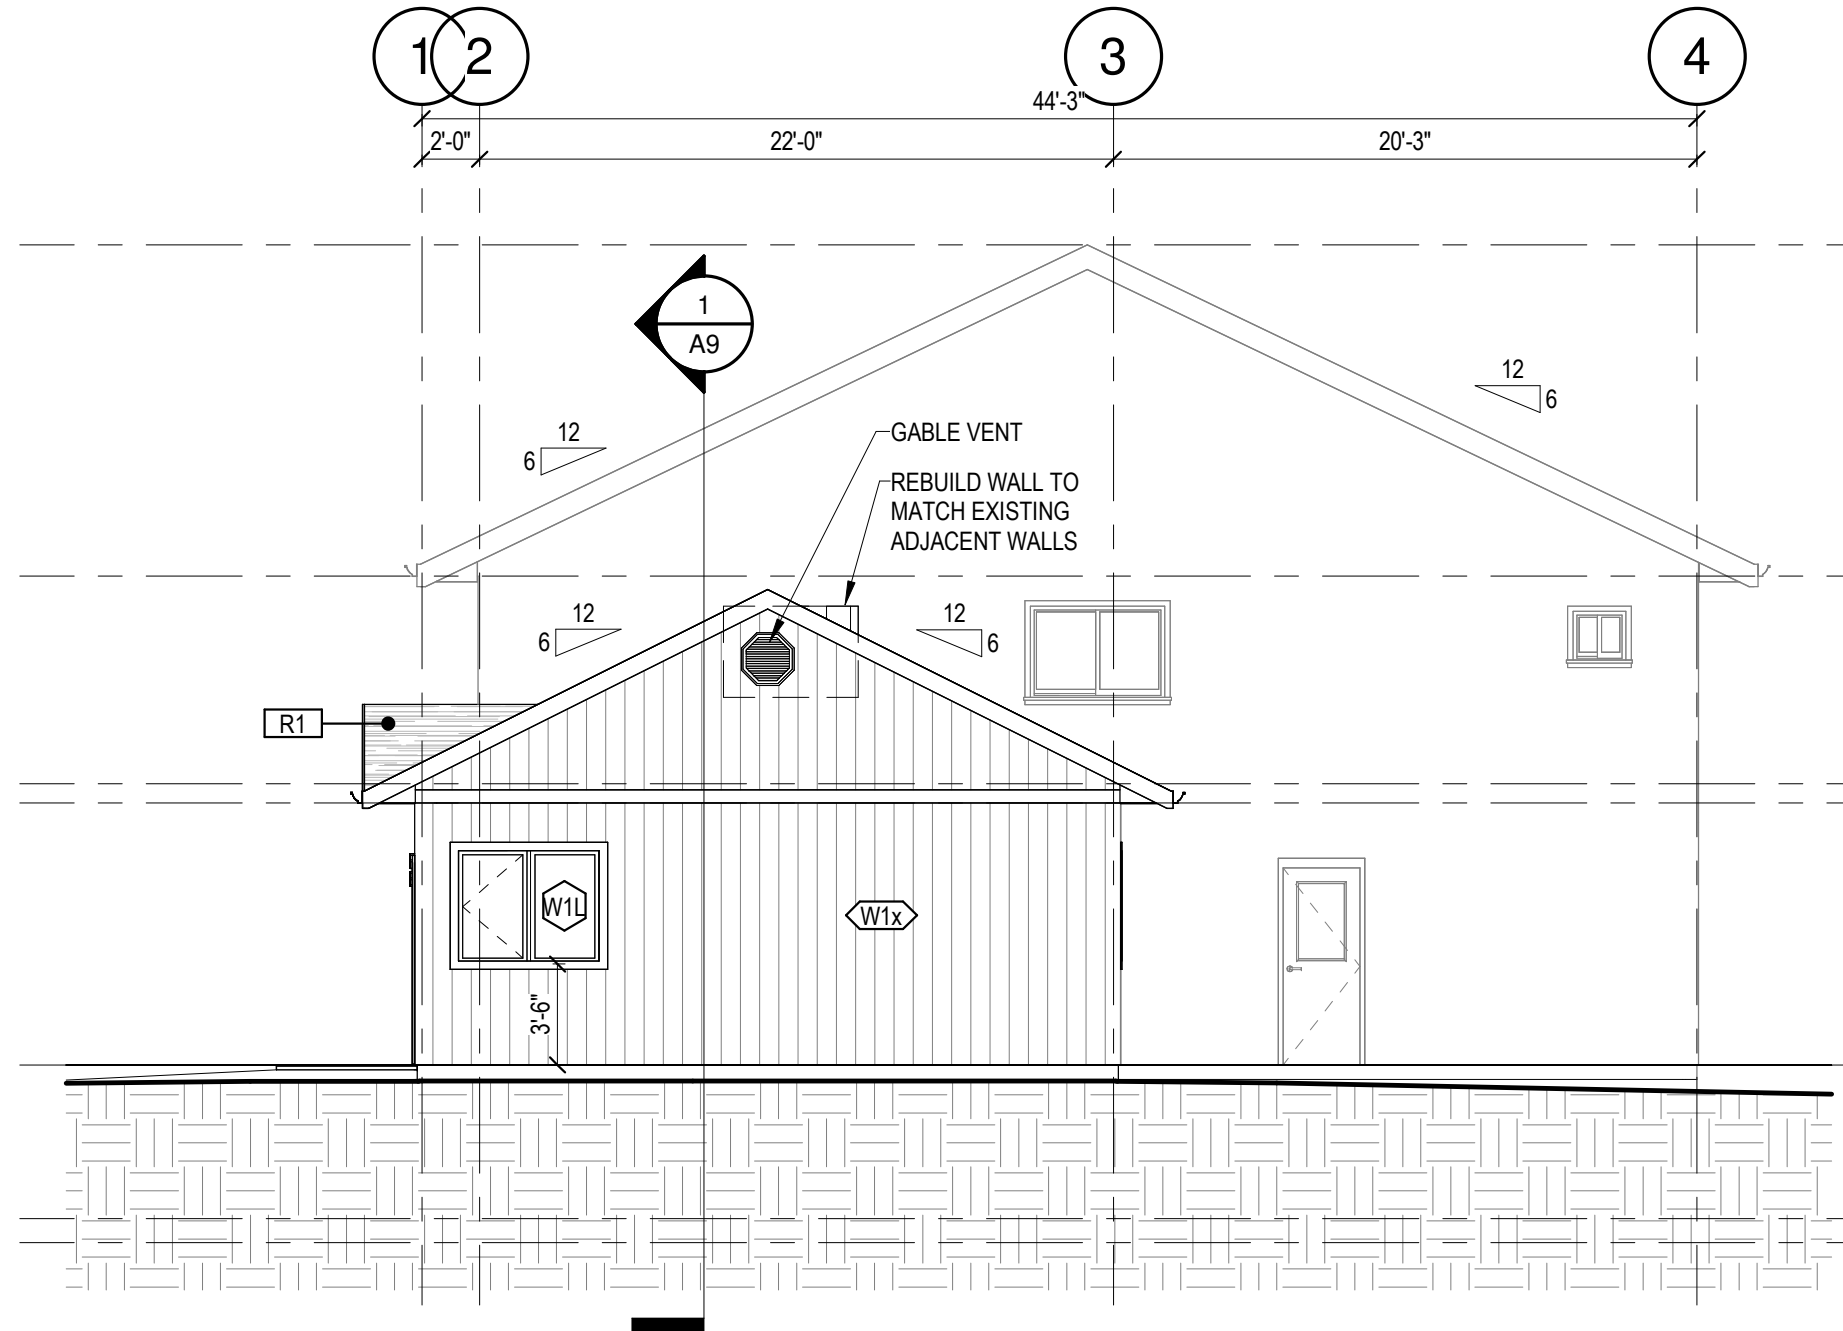

**3 NORTH ELEVATION - NEW**  
A8 SCALE : 1 : 80

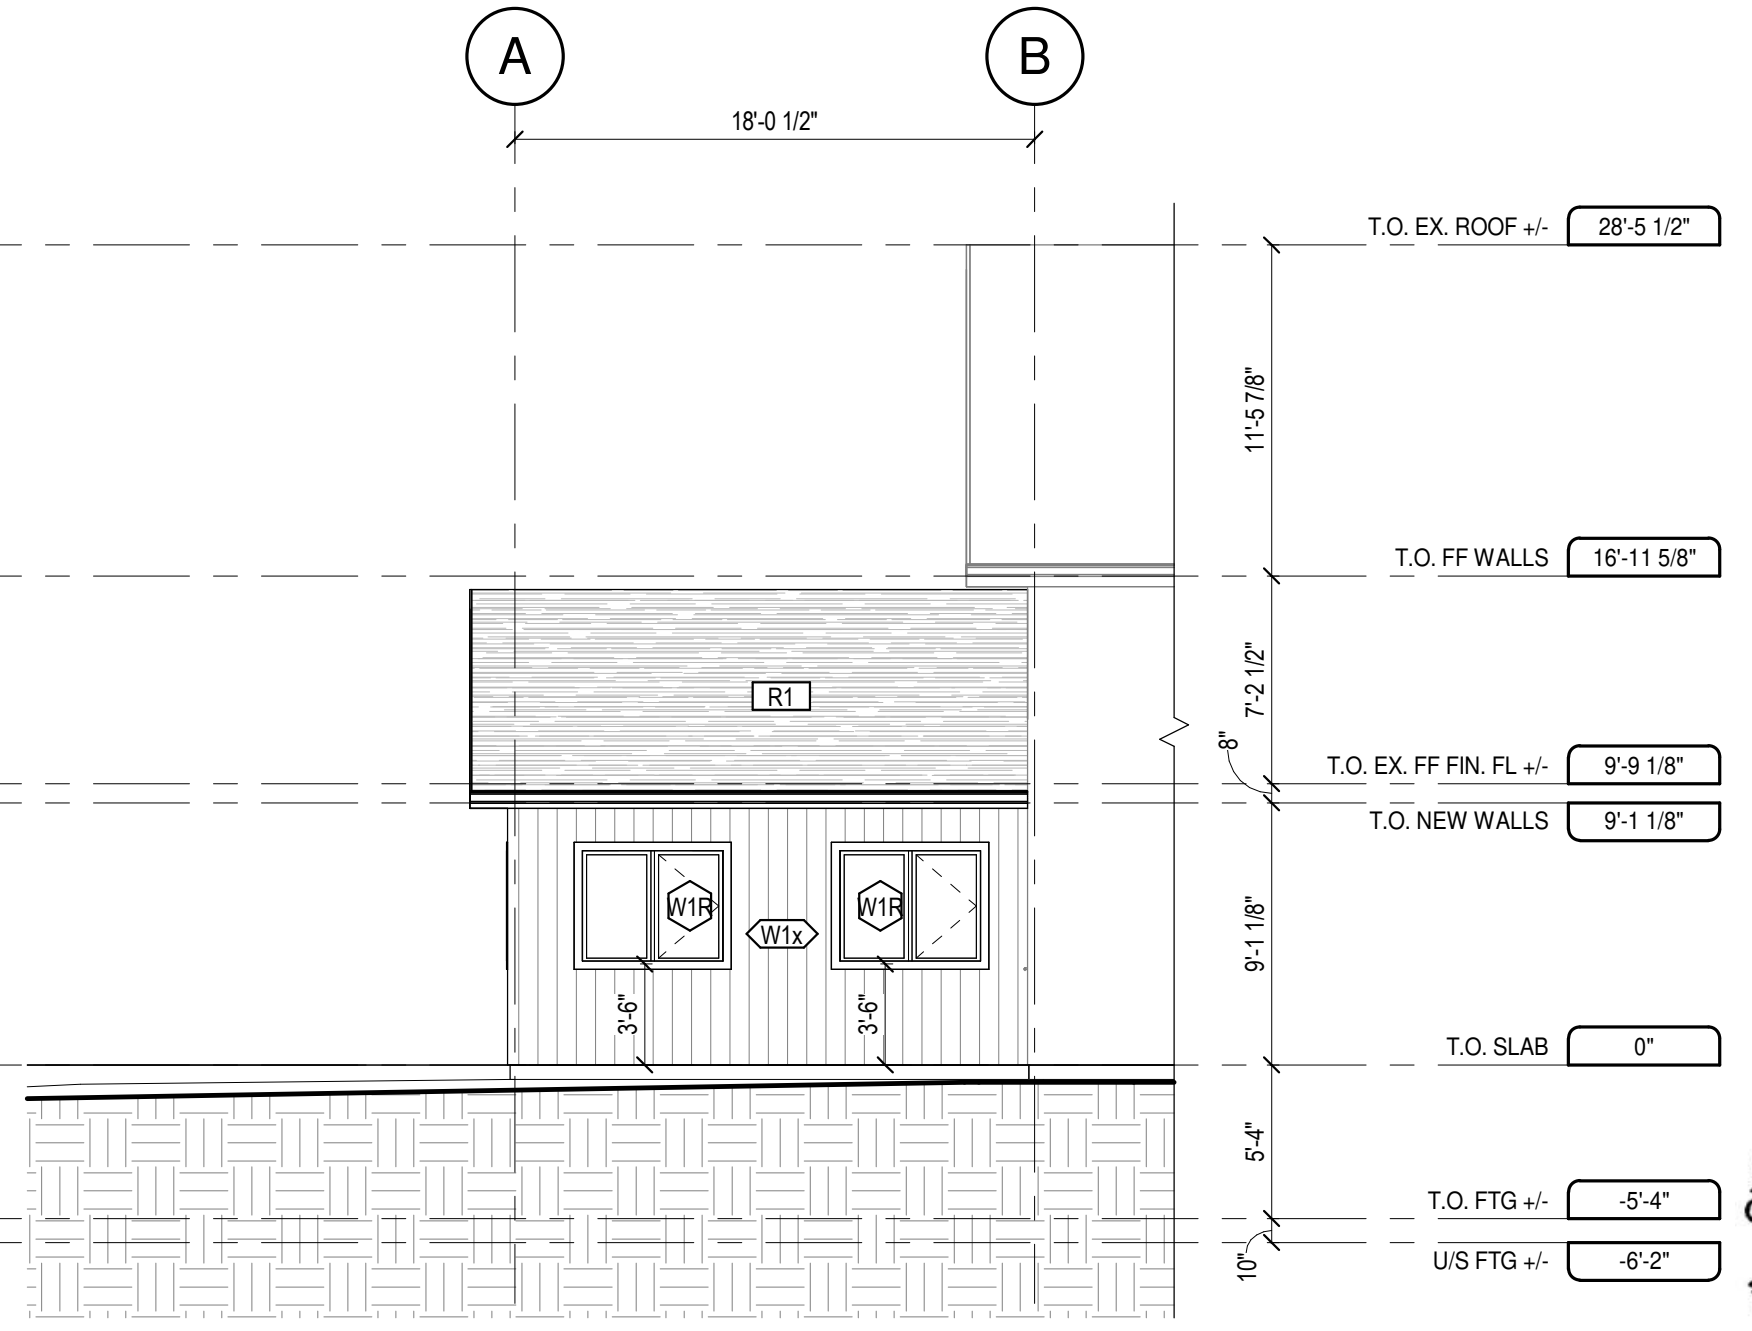

**4 WEST ELEVATION - NEW**  
A8 SCALE : 1 : 80

**DRAWING NOTES:**  
1. THE REQUIRED MIN. LIMITING DISTANCE HAS BEEN DOUBLED AS PER OBC 3.2.3.1.(8).



DATE STAMP: 2023-07-26 11:29:16 AM FILE PATH: D:\RIVARC\_Sharing\Projects\22013 Hilliard Town Office Addition\2 Working\Model\22013\_HilliardTownOfficeAddition\_Model.rvt

**rivarC**  
— DRAFTING & DESIGN —  
sean@rivarC.ca | 705.648.3155 | nvarC.ca

**ryancompanyarchitectinc**

Rev.	Description	Date
1	Issued for Client Review	23.04.14
2	Issued for Tender	23.07.26

**Hilliard TOWNSHIP**  
Since 1810

**Drawing Title**  
**EXTERIOR ELEVATIONS**

**Project Title**  
HILLIARD TOWNSHIP OFFICE ADDITION - PHASE 1  
951678 Hwy 569, Hilliardton, ON, P0J 1L0


**Professional Stamp**  
\*I REVIEWED THIS DOCUMENT AND TAKE RESPONSIBILITY FOR THIS DESIGN. I AM QUALIFIED, AND THE FIRM IS REGISTERED, IN THE APPROPRIATE CLASSIFICATION AS PER SUBSECTION 3.2.4 OF DIVISION C OF THE BUILDING CODE.\*

**rivarC** Sean Rivard  
BCIN # 110013 BCIN # 102394


*Sean Rivard*  
SIGNATURE

Scale	1 : 80
Sheet Size	18 x 24"
Revision	2
Drawn By	SWR

Project No.	22013
Date	23.07.26
Drawing No.	<b>A8</b>

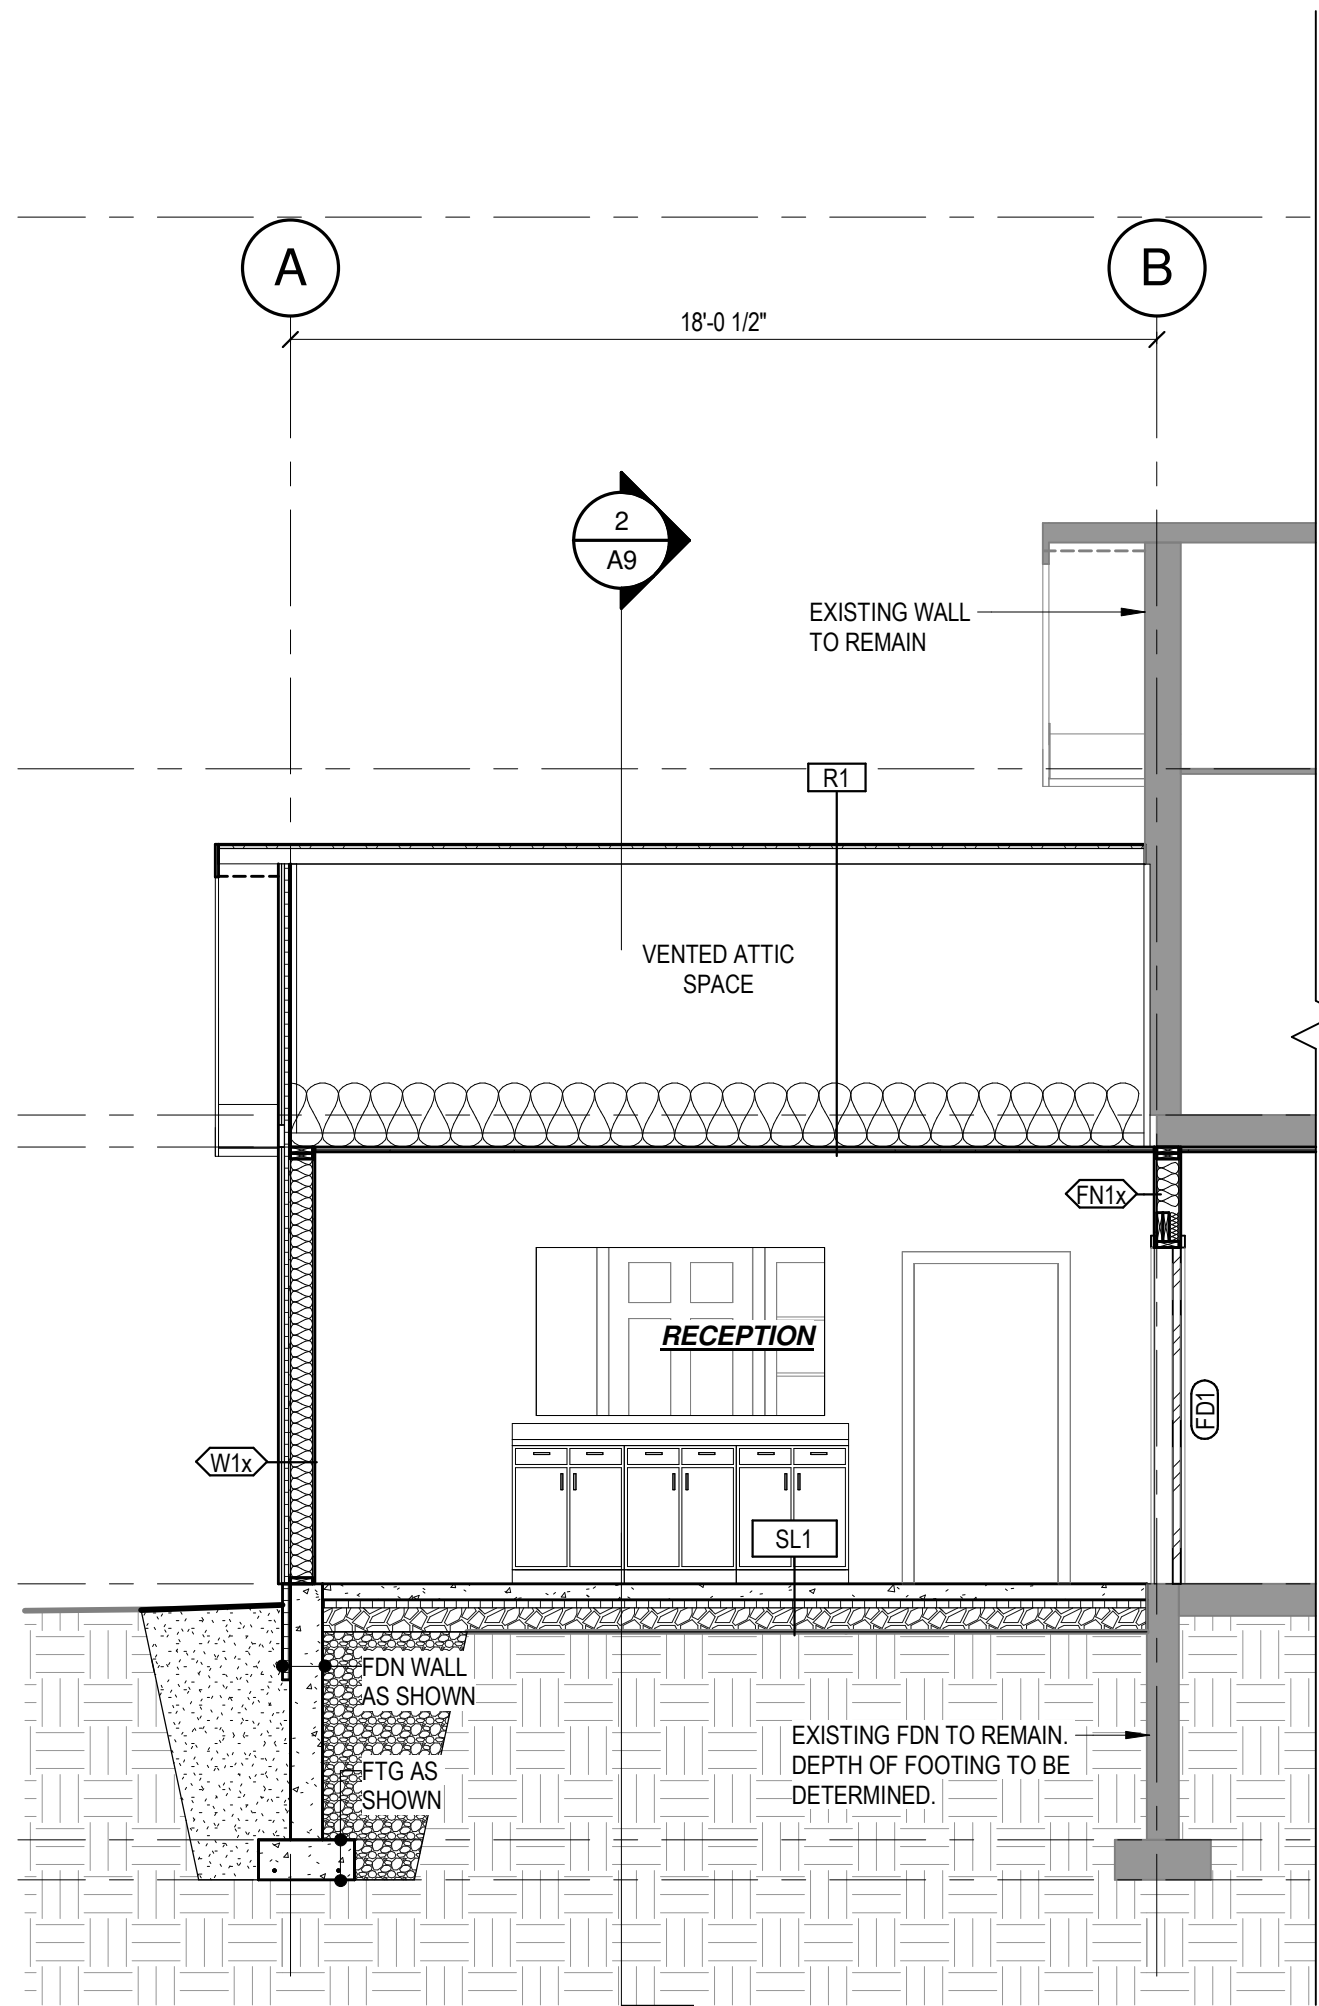

**1** NEW ADDITION SECTION 1  
A9 SCALE : 1/4" = 1'-0"

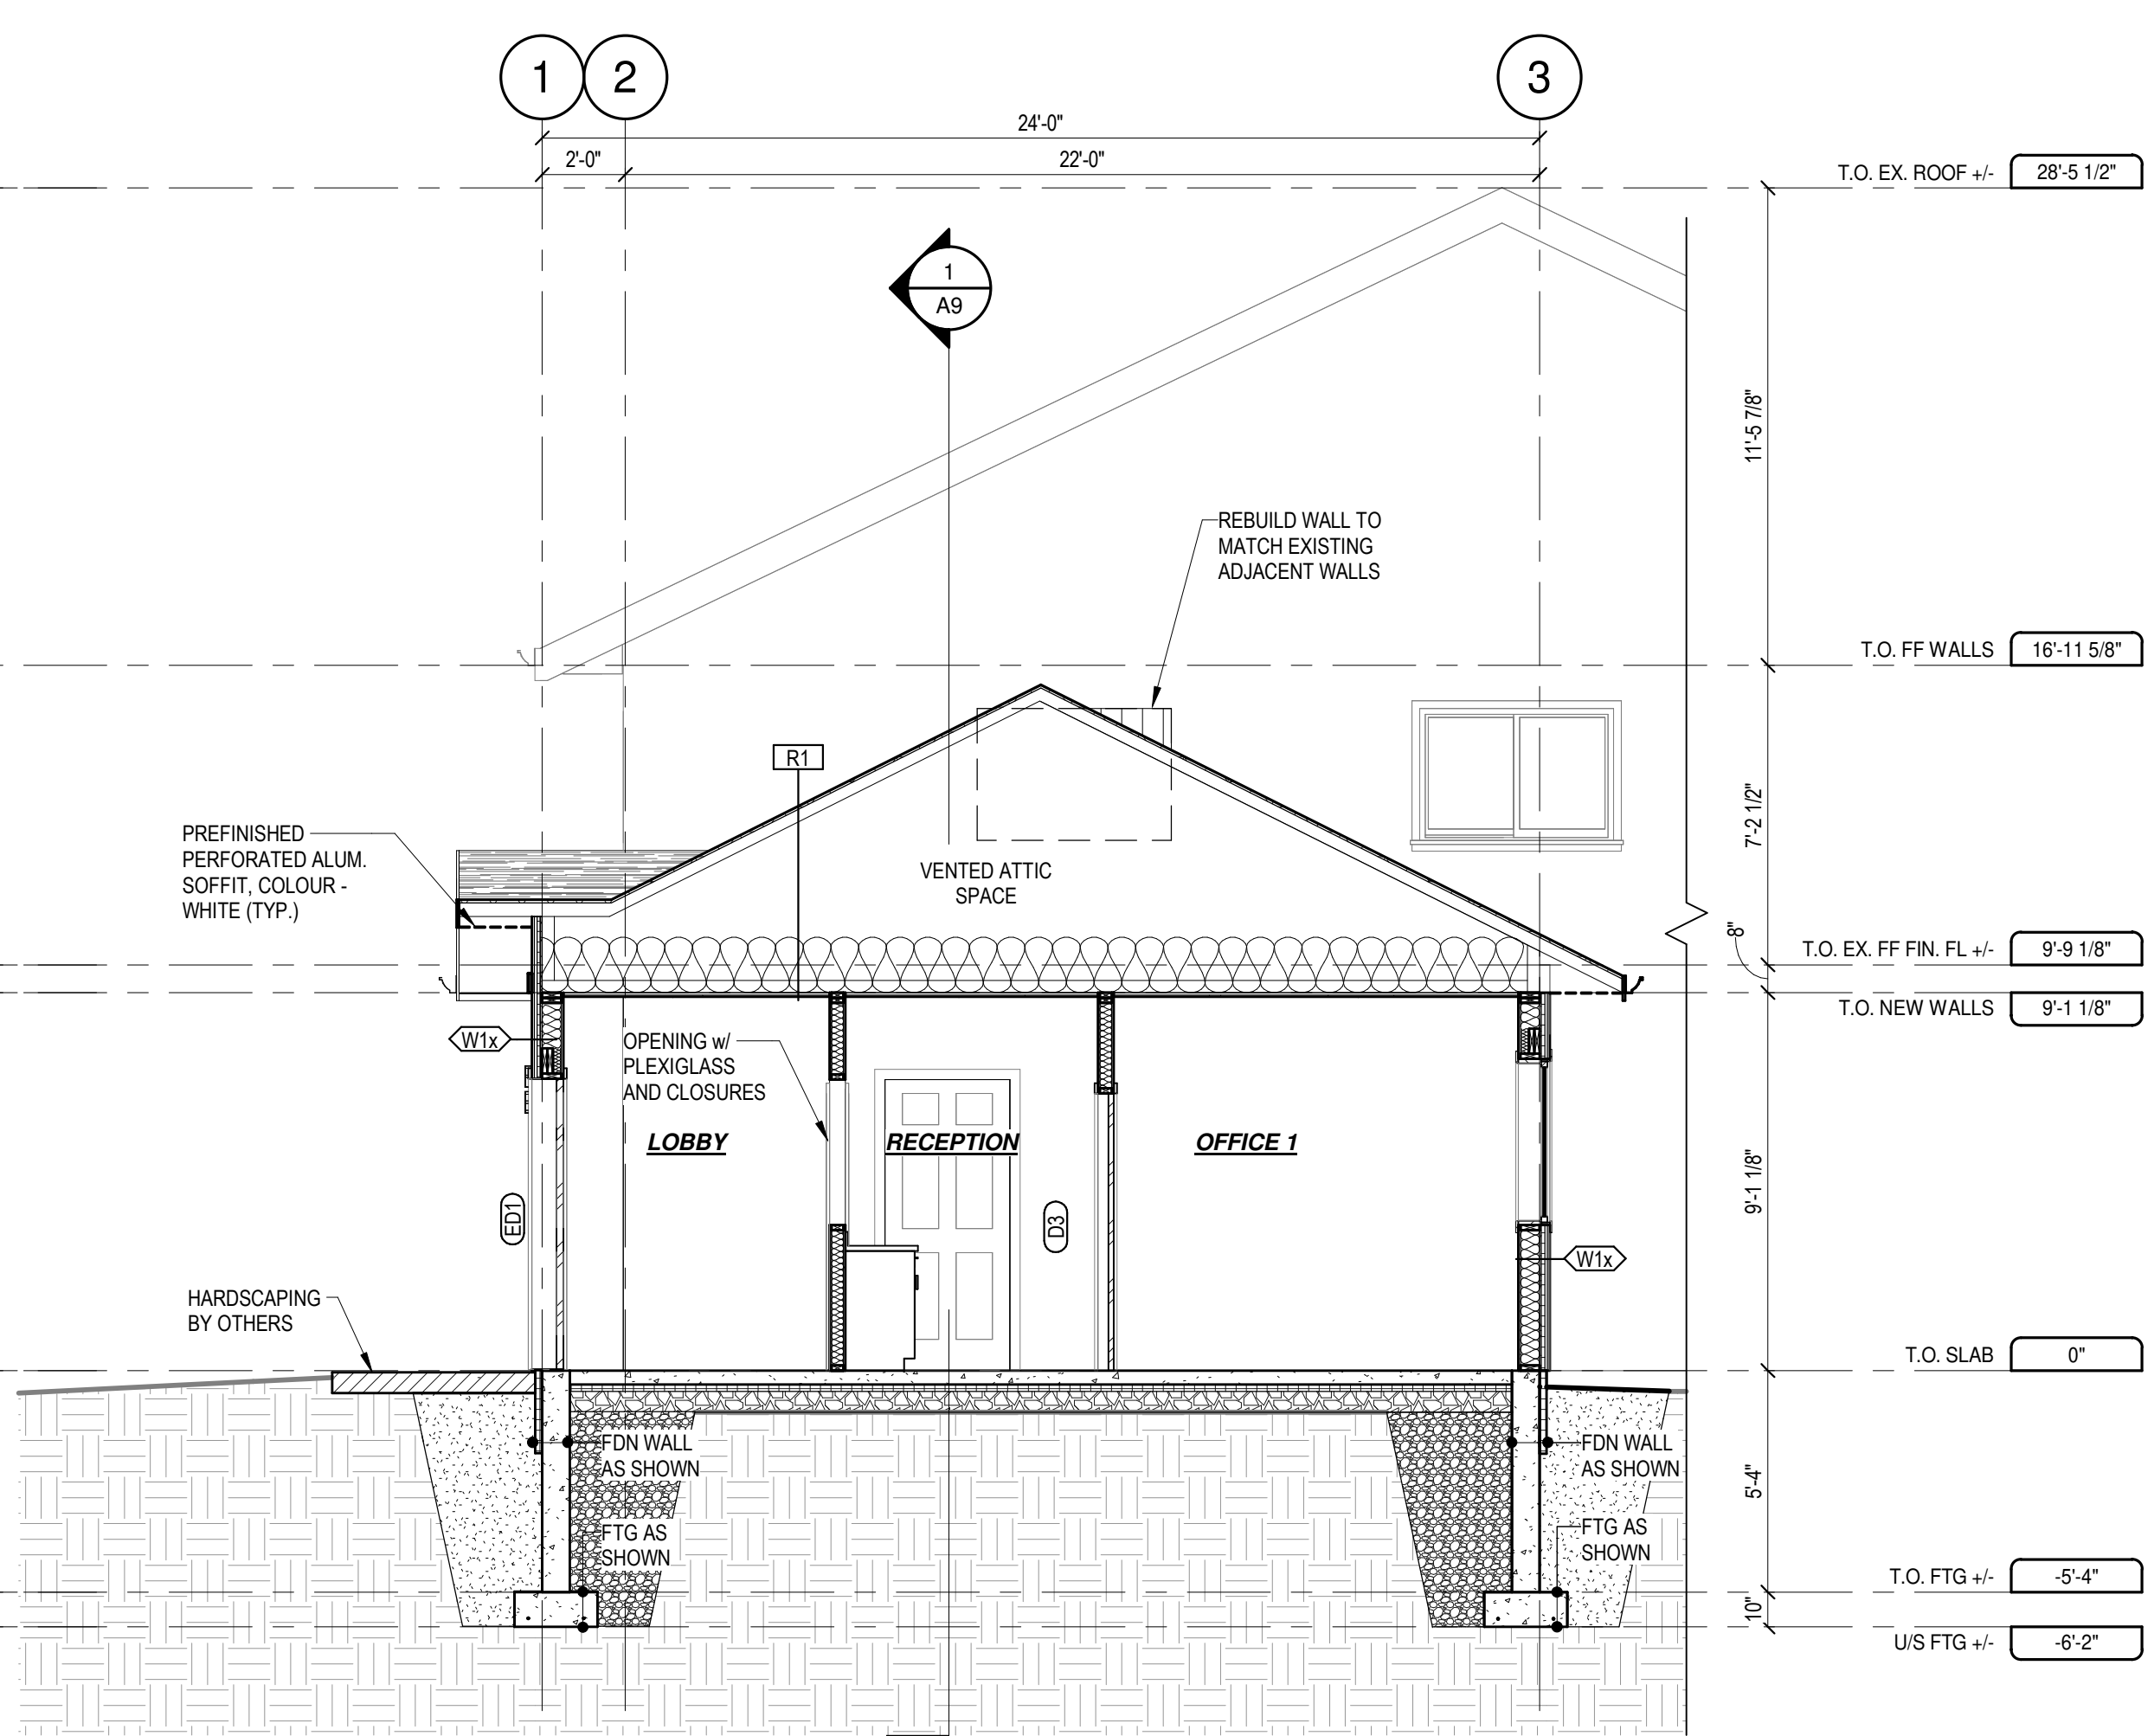

**2** NEW ADDITION SECTION 2  
A9 SCALE : 1/4" = 1'-0"



DATE STAMP: 2023-07-26 11:29:17 AM FILE PATH: D:\RIVARC\_Shared\Projects\22013 Hilliard Town Office Addition\Working\Model\22013\_HilliardTwp\_OfficeAddition\_Model.rvt

**rivarc**  
— DRAFTING & DESIGN —  
sean@rivarc.ca | 705.648.3155 | rivarc.ca

**ryancompanyarchitectinc**

Plan Orientation	Rev. Description	Date	Client
	1 Issued for Tender	23.07.26	Hilliard Township

**Hilliard TOWNSHIP**  
Since 1810

**Drawing Title**  
BUILDING SECTIONS & DETAILS

**Project Title**  
HILLIARD TOWNSHIP OFFICE ADDITION - PHASE 1  
951678 Hwy 569, Hilliardton, ON, P0J 1L0

<b>Professional Stamp</b> *I REVIEWED THIS DOCUMENT AND TAKE RESPONSIBILITY FOR THIS DESIGN. I AM QUALIFIED, AND THE FIRM IS REGISTERED, IN THE APPROPRIATE CLASSIFICATION AS PER SUBSECTION 3.2.4 OF DIVISION C OF THE BUILDING CODE.* rivarc Sean Rivard BCIN # 110013 BCIN # 102394 <i>Sean Rivard</i> SIGNATURE	Scale 1/4" = 1'-0"
Sheet Size 18 x 24"	Project No. 22013
Revision 1	Date 23.07.26
Drawn By SWR	Drawing No. A9



DATE STAMP: 2023-07-26 11:29:17 AM FILE PATH: D:\RIVARC\_Shared\Projects\2023\Hilliard Town Office Addition\2-Working\Models\2023\3\_Hilliard\Top-Office-Addition\_Model.rvt

DOOR SCHEDULE										
No.	ROOM	DOOR SIZE		LINTEL SIZE	DOOR TYPE	DOOR STYLE	DOOR FINISH	FRR	GLAZING TYPE	REMARKS
		WIDTH	HEIGHT							
D1	RECEPTION	36"	80"	N/A	WD-1	SWING	PAINT		N/A	LHR - EQUIPPED w/ LOCK SET, LEVER TYPE HANDLES
D2	OFFICE 2	30"	80"	N/A	WD-2	SWING	PAINT		N/A	RH
D3	OFFICE 1	30"	80"	N/A	WD-2	SWING	PAINT		N/A	LH
ED1	LOBBY	36"	84"	AS SHOWN	ACD-1	SWING w/ 24" SIDELIGHT	PRE-FINISHED ALUM.	30 min	CLEAR	RH - EQUIPPED w/ VISION LITE IN DOOR PANEL, SIDELIGHT, LOCK SET, (1) PANIC PUSH BAR, DOOR SILL, SELF-CLOSING DEVICE, DOOR STOP, WEATHER STRIPPING, THRESHOLD AND KICK PLATE, (1) ELEC. DOOR OPENING DEVICE. DOOR ROUGH OPENING TO SUIT 5/8" DRYWALL TYPE X TO BE INSTALLED ON THE THREE SIDES OF WOOD FRAMING TO ENSURE CONTINUITY OF FRR.
FD1	RECEPTION	36"	84"	AS SHOWN	ACD-2	SWING	PRE-FINISHED ALUM.	45 min	N/A	LH - EQUIPPED w/ LEVER TYPE HANDLES, SELF-CLOSING DEVICE AND SMOKE SEAL
TOTAL UNITS: 5										

**DOOR SCHEDULE NOTES:**  
 1. CONFIRM ALL ROUGH STUD OPENING (RSO) DIMENSIONS WITH DOOR MANUFACTURER'S RECOMMENDED SPECIFICATIONS PRIOR TO FRAMING. ADJUST AS PER CONTRACTOR'S PREFERENCE AS REQUIRED.

**DOOR SCHEDULE LEGEND:**  
 ACD = ALUMINUM CLAD DOOR  
 ACOD = ALUMINUM CLAD OVERHEAD DOOR  
 FRR = FIRE RESISTANCE RATING  
 GBG = GRILLES BETWEEN GLASS  
 LH = LEFT HAND  
 LHR = LEFT HAND REVERSED  
 OD = OVERHEAD DOOR  
 RH = RIGHT HAND  
 RHR = RIGHT HAND REVERSED  
 VCD = VINYL CLAD DOOR  
 WD = WOOD DOOR

WINDOW SCHEDULE										
No.	TOTAL COUNT	WINDOW SIZE		LINTEL SIZE	TYPE DESCRIPTION	HANDING	FRAME MATERIAL	FRAME FINISH	GLAZING	REMARKS
		WIDTH	HEIGHT						TYPE	
W1L	1	60"	48"	AS SHOWN	DOUBLE CASEMENT c/w SCREEN(S)	FCL	INSULATED ALUM./VINYL HYBRID	PRE-FINISHED PAINT	CLEAR	DOUBLE PANE ARGON FILLED GLAZING
W1R	2	60"	48"	AS SHOWN	DOUBLE CASEMENT c/w SCREEN(S)	FCR	INSULATED ALUM./VINYL HYBRID	PRE-FINISHED PAINT	CLEAR	DOUBLE PANE ARGON FILLED GLAZING
TOTAL UNITS: 3										

**WINDOW SCHEDULE NOTES:**  
 1. SEE BUILDING ELEVATIONS FOR WINDOW SILL HEIGHTS. SILL HEIGHTS ARE MEASURED TO WINDOW FROM (NOT TO ROUGH OPENING).  
 2. CONFIRM ALL ROUGH STUD OPENING (RSO) DIMENSIONS WITH WINDOW MANUFACTURER'S RECOMMENDED SPECIFICATIONS PRIOR TO FRAMING. ADJUST AS PER CONTRACTOR'S PREFERENCE AS REQUIRED.

**WINDOW SCHEDULE LEGEND:**  
 FCL = HINGES LOCATED ON LEFT SIDE OF FRAME  
 FCR = HINGES LOCATED ON RIGHT SIDE OF FRAME  
 GBG = GRILLES BETWEEN GLASS



Plan Orientation

Rev. Description  
 1 Issued for Tender

Date  
 23.07.26

Client



Drawing Title

WINDOW & DOOR SCHEDULES

Project Title

HILLIARD TOWNSHIP OFFICE ADDITION - PHASE 1  
 951678 Hwy 569, Hilliardton, ON, P0J 1L0

Professional Stamp

\*I REVIEWED THIS DOCUMENT AND TAKE RESPONSIBILITY FOR THIS DESIGN. I AM QUALIFIED, AND THE FIRM IS REGISTERED, IN THE APPROPRIATE CLASSIFICATION AS PER SUBSECTION 3.2.4 OF DIVISION C OF THE BUILDING CODE.\*

RIVARC Sean Rivard  
 BCIN # 110013 BCIN # 102394

*Sean Rivard*  
 SIGNATURE

Scale

Sheet Size 18 x 24"

Revision 1





Drawn By SWR

Project No. 22013

Date 23.07.26

Drawing No.

A10

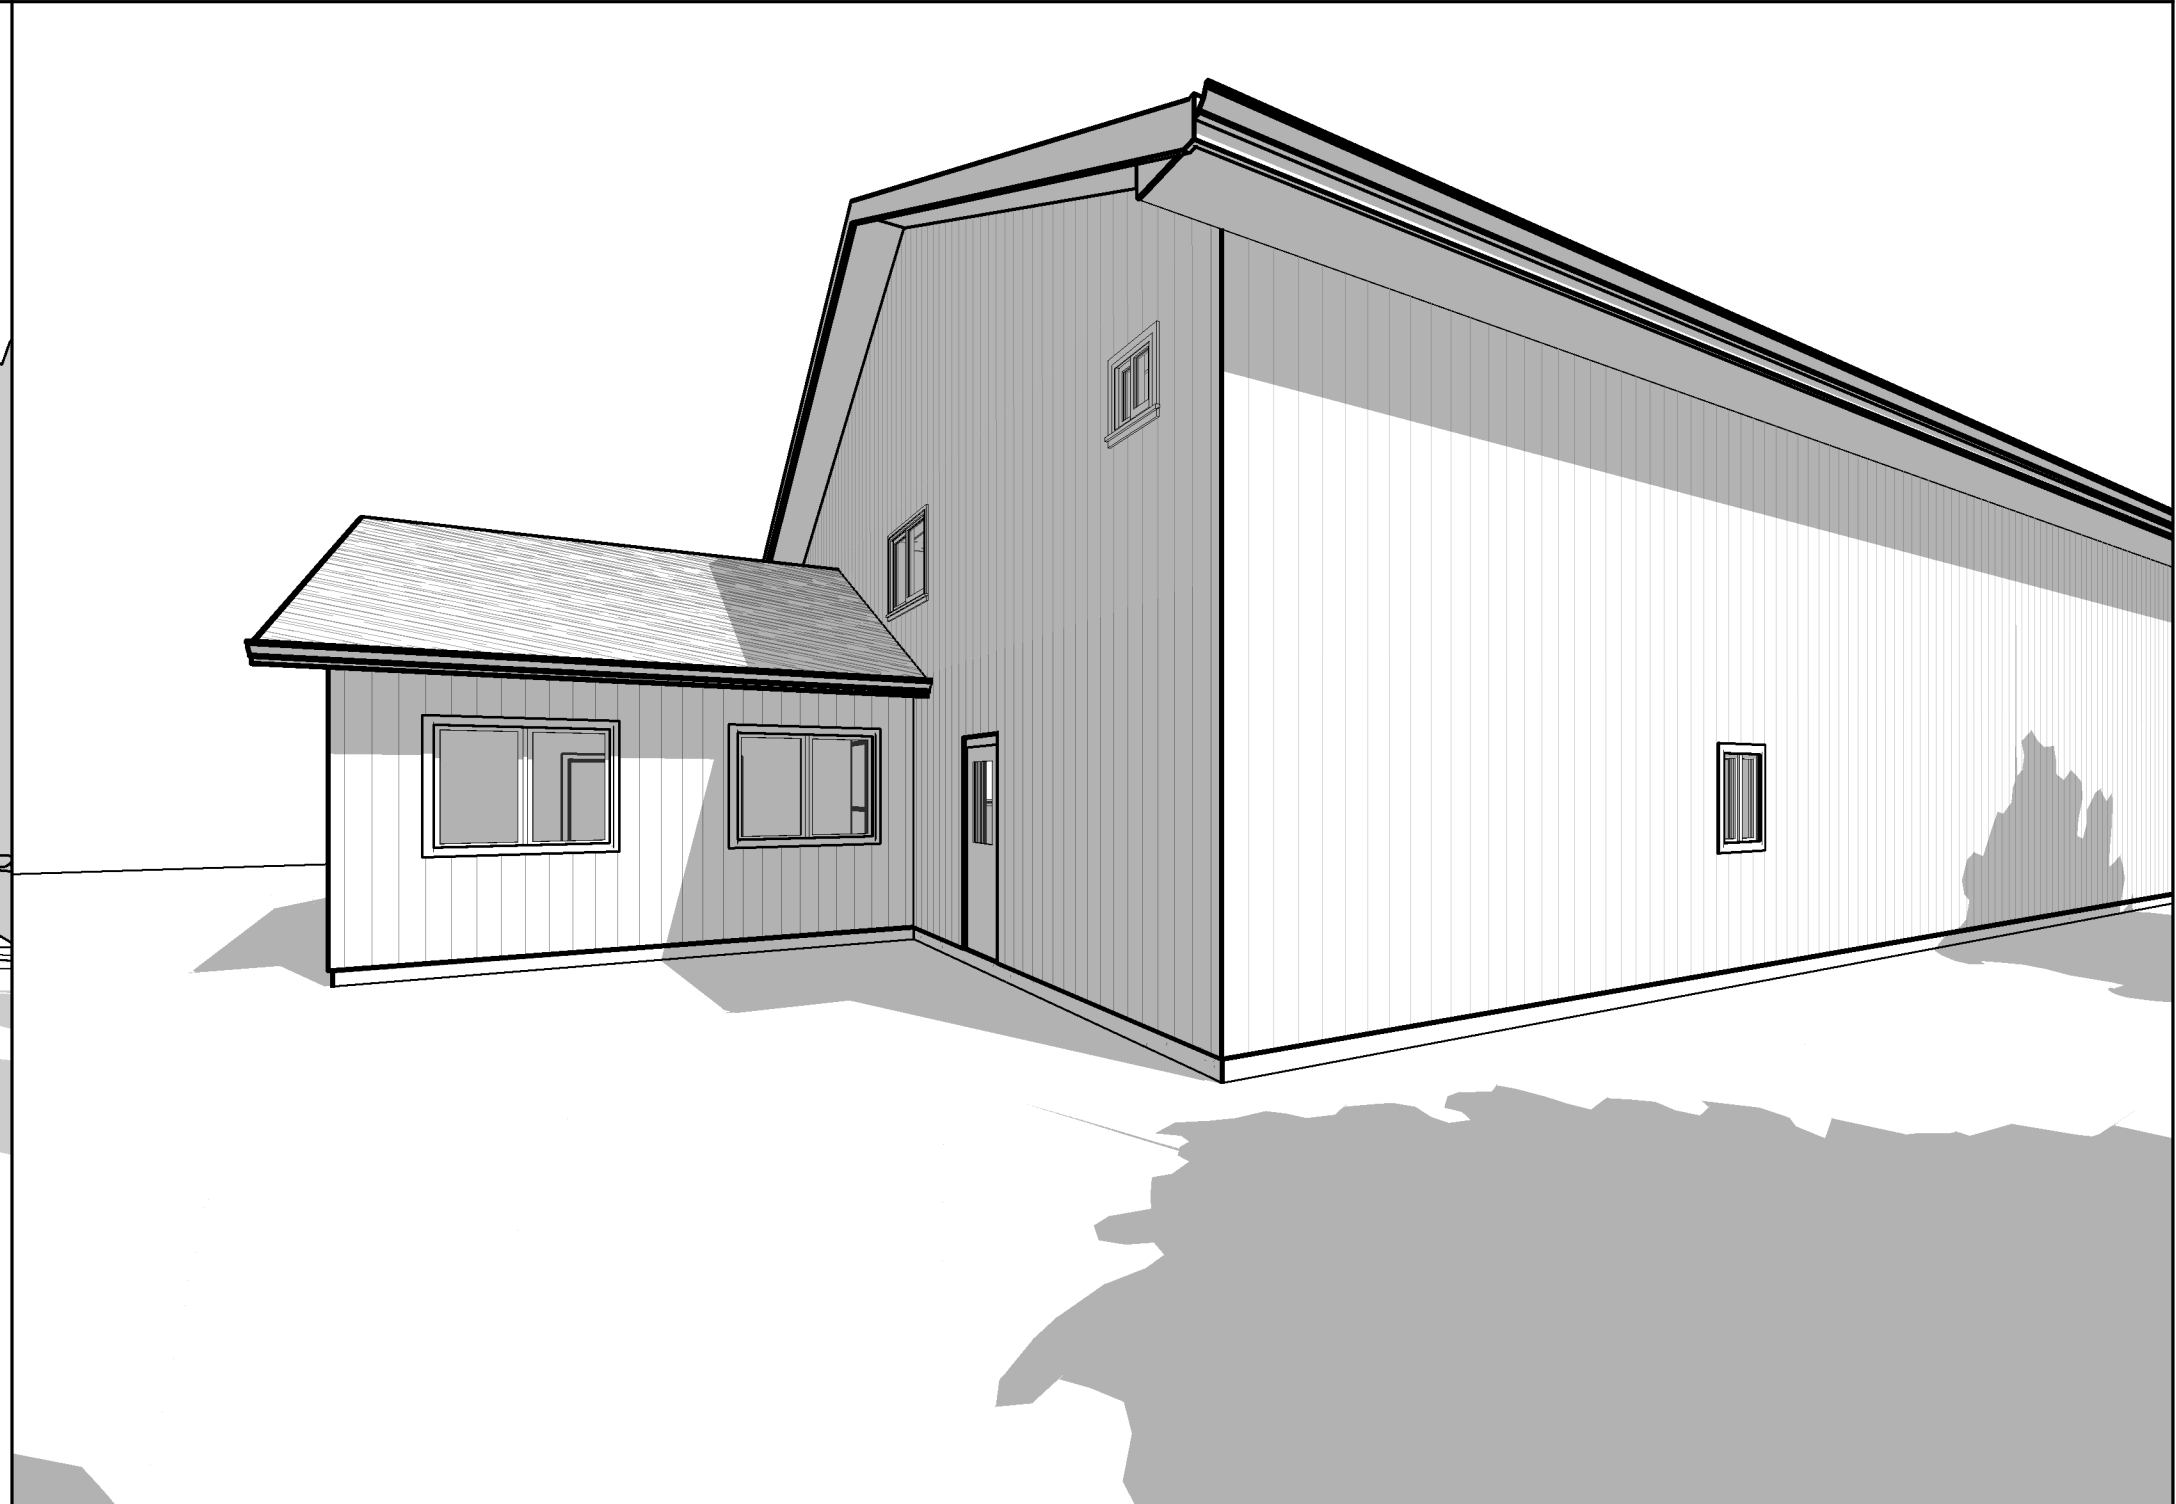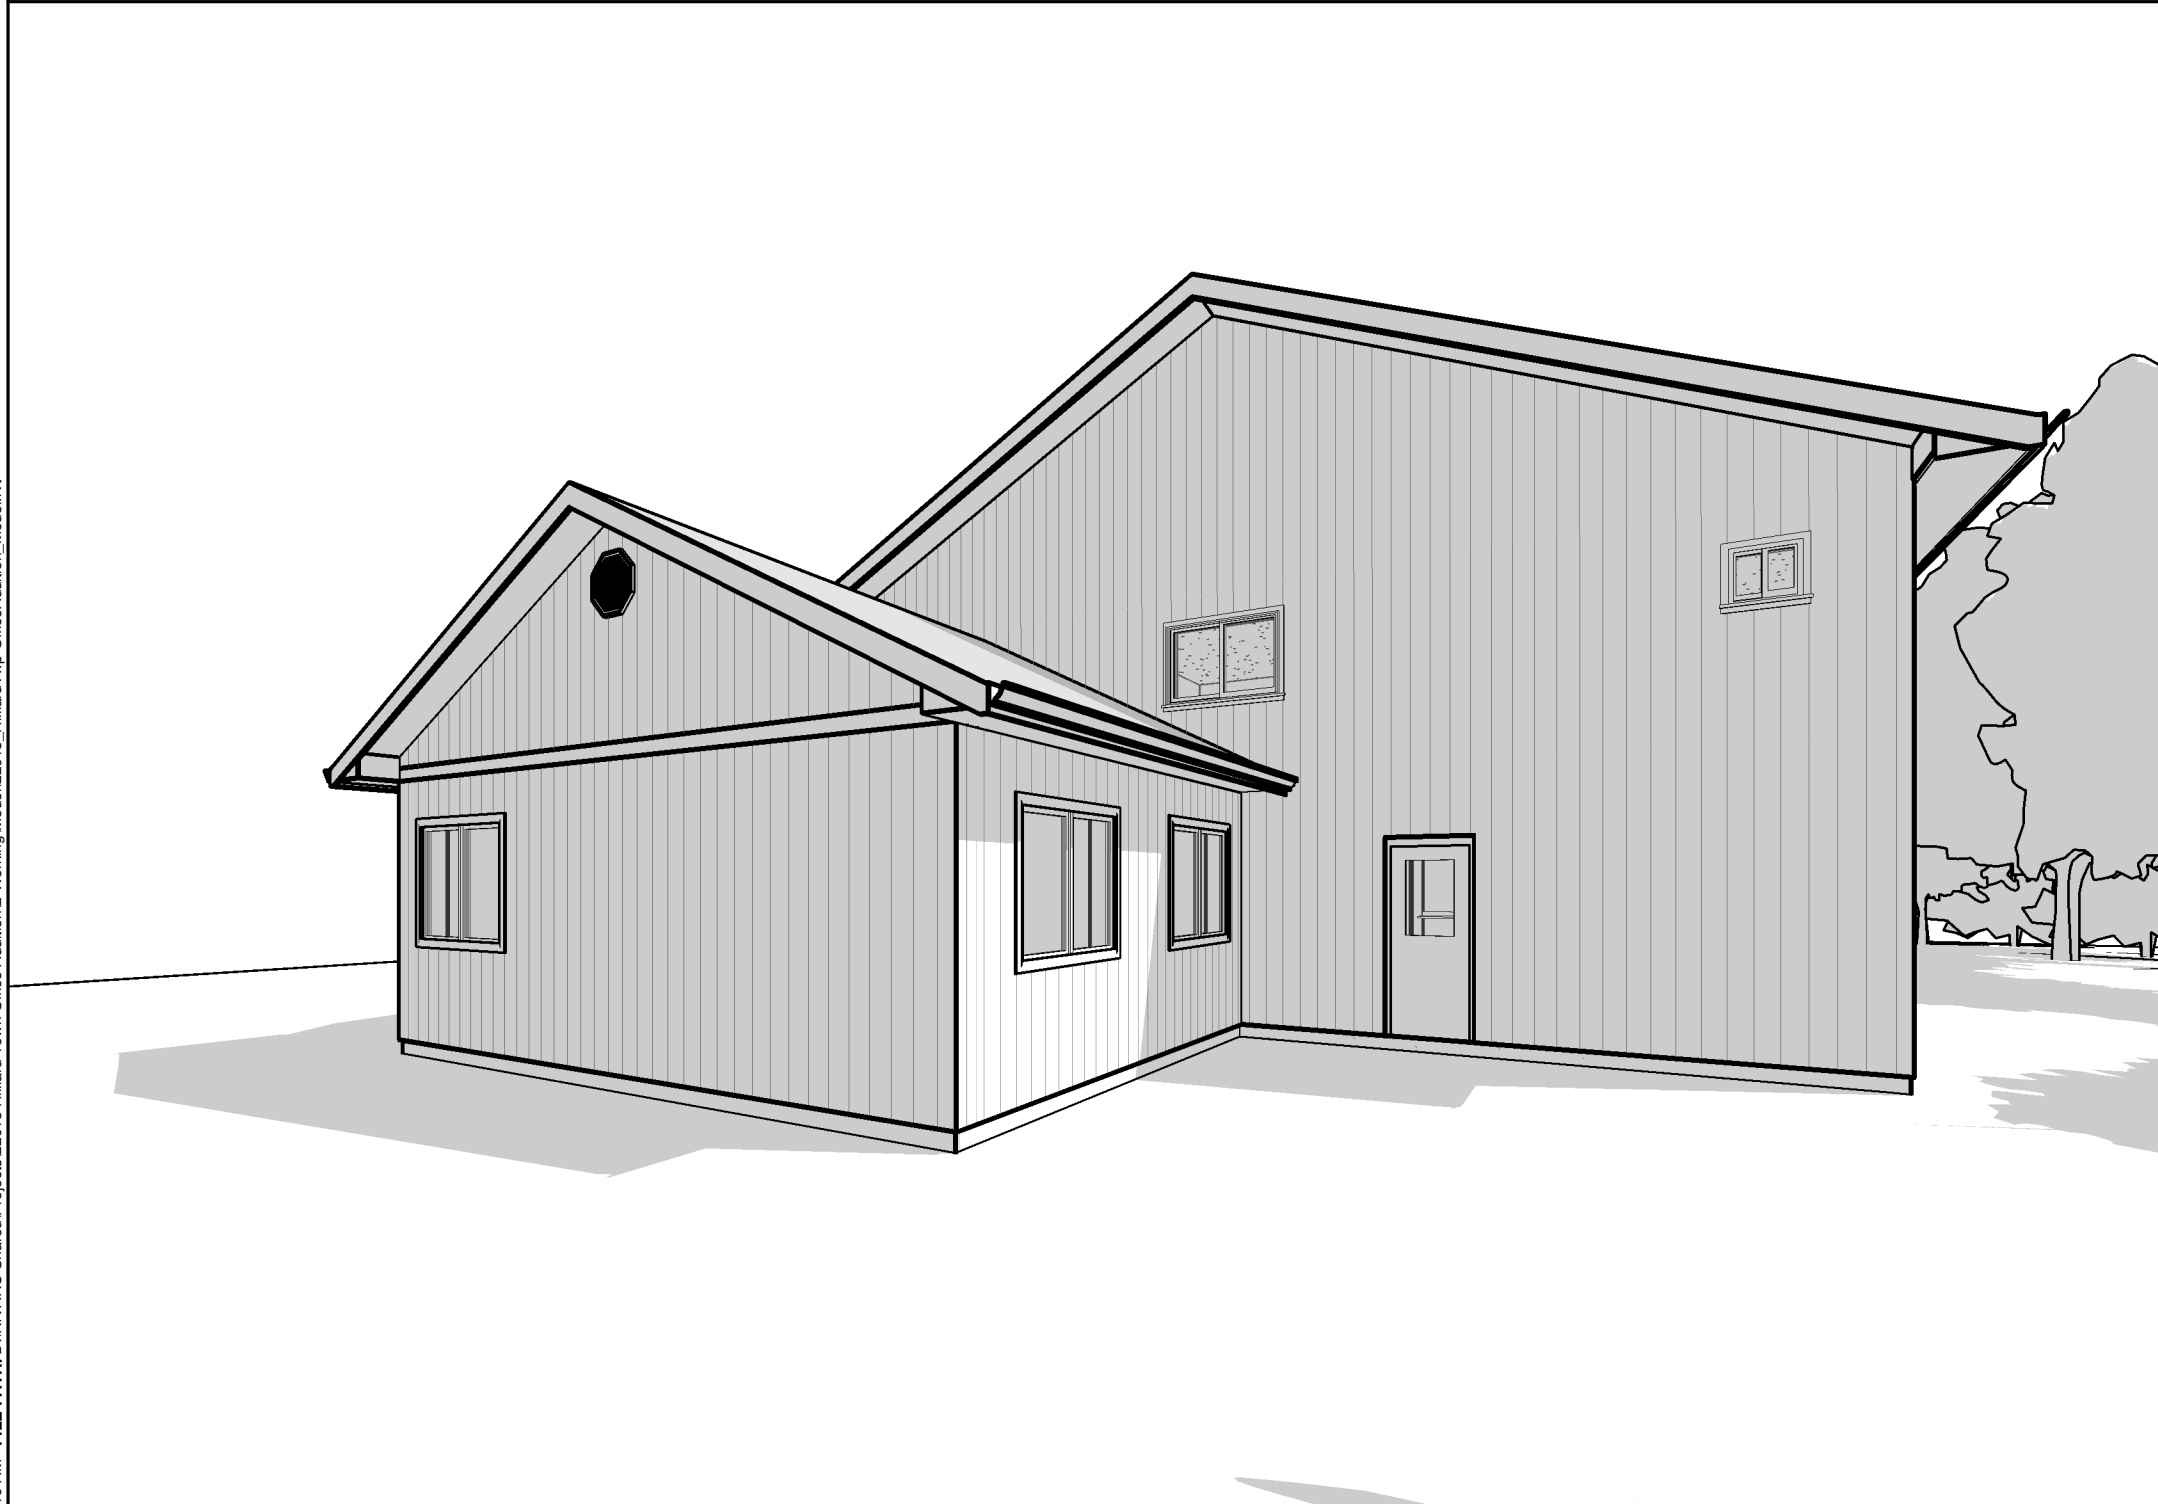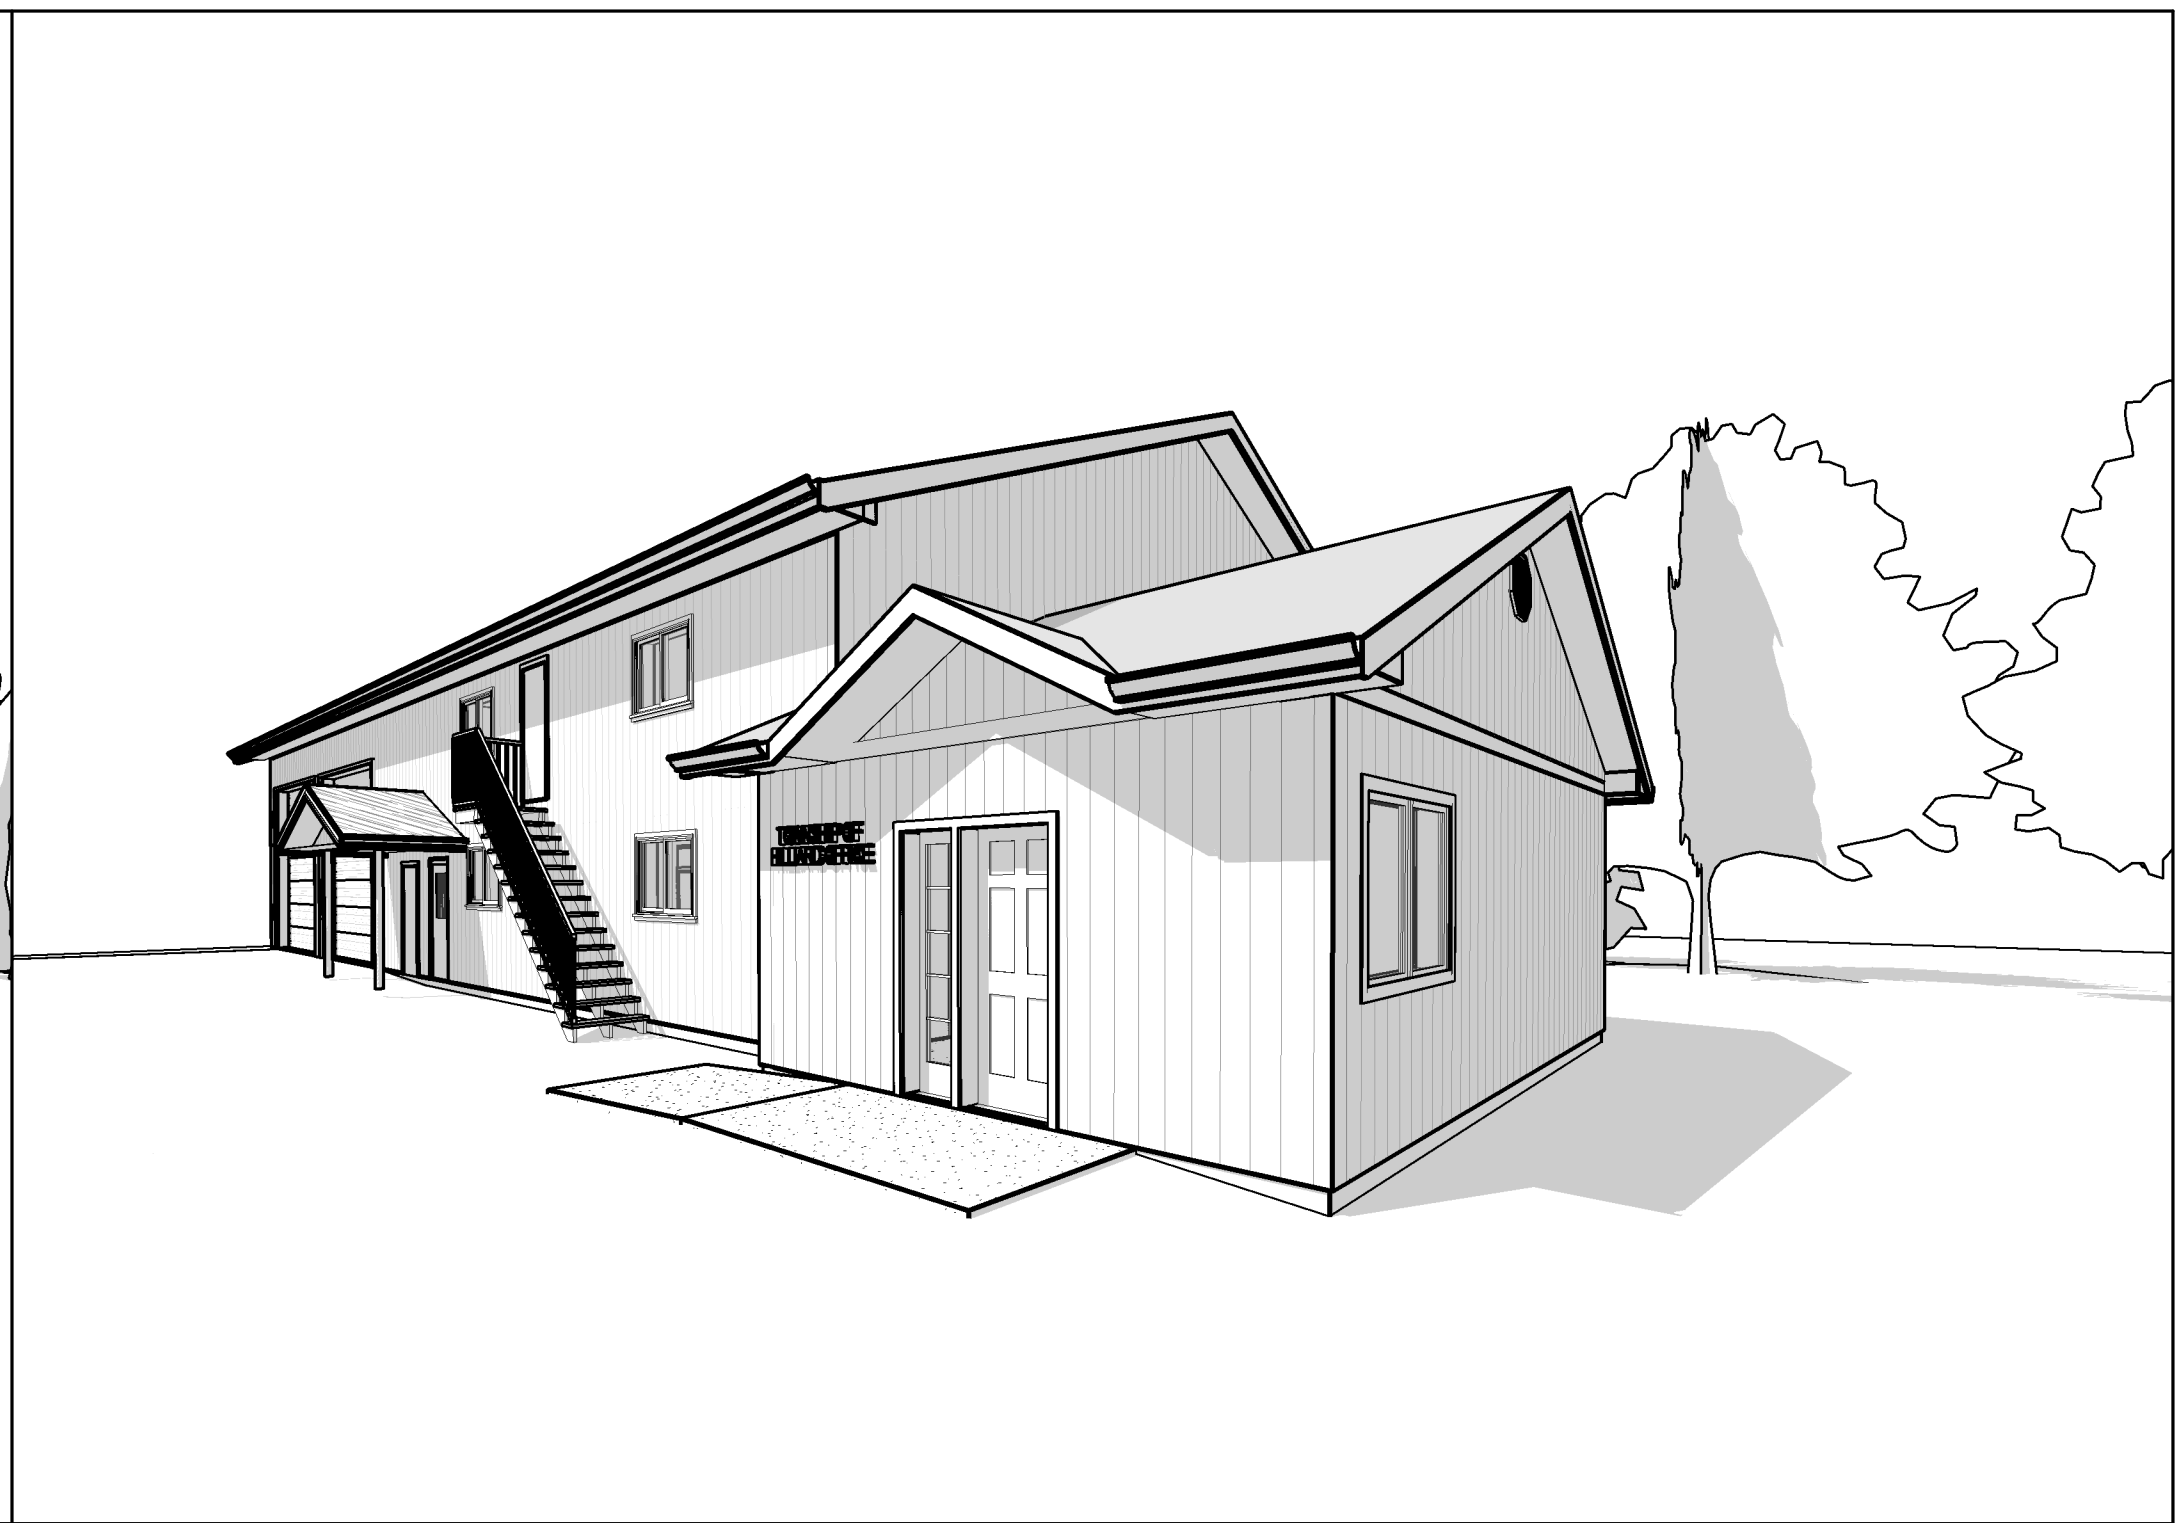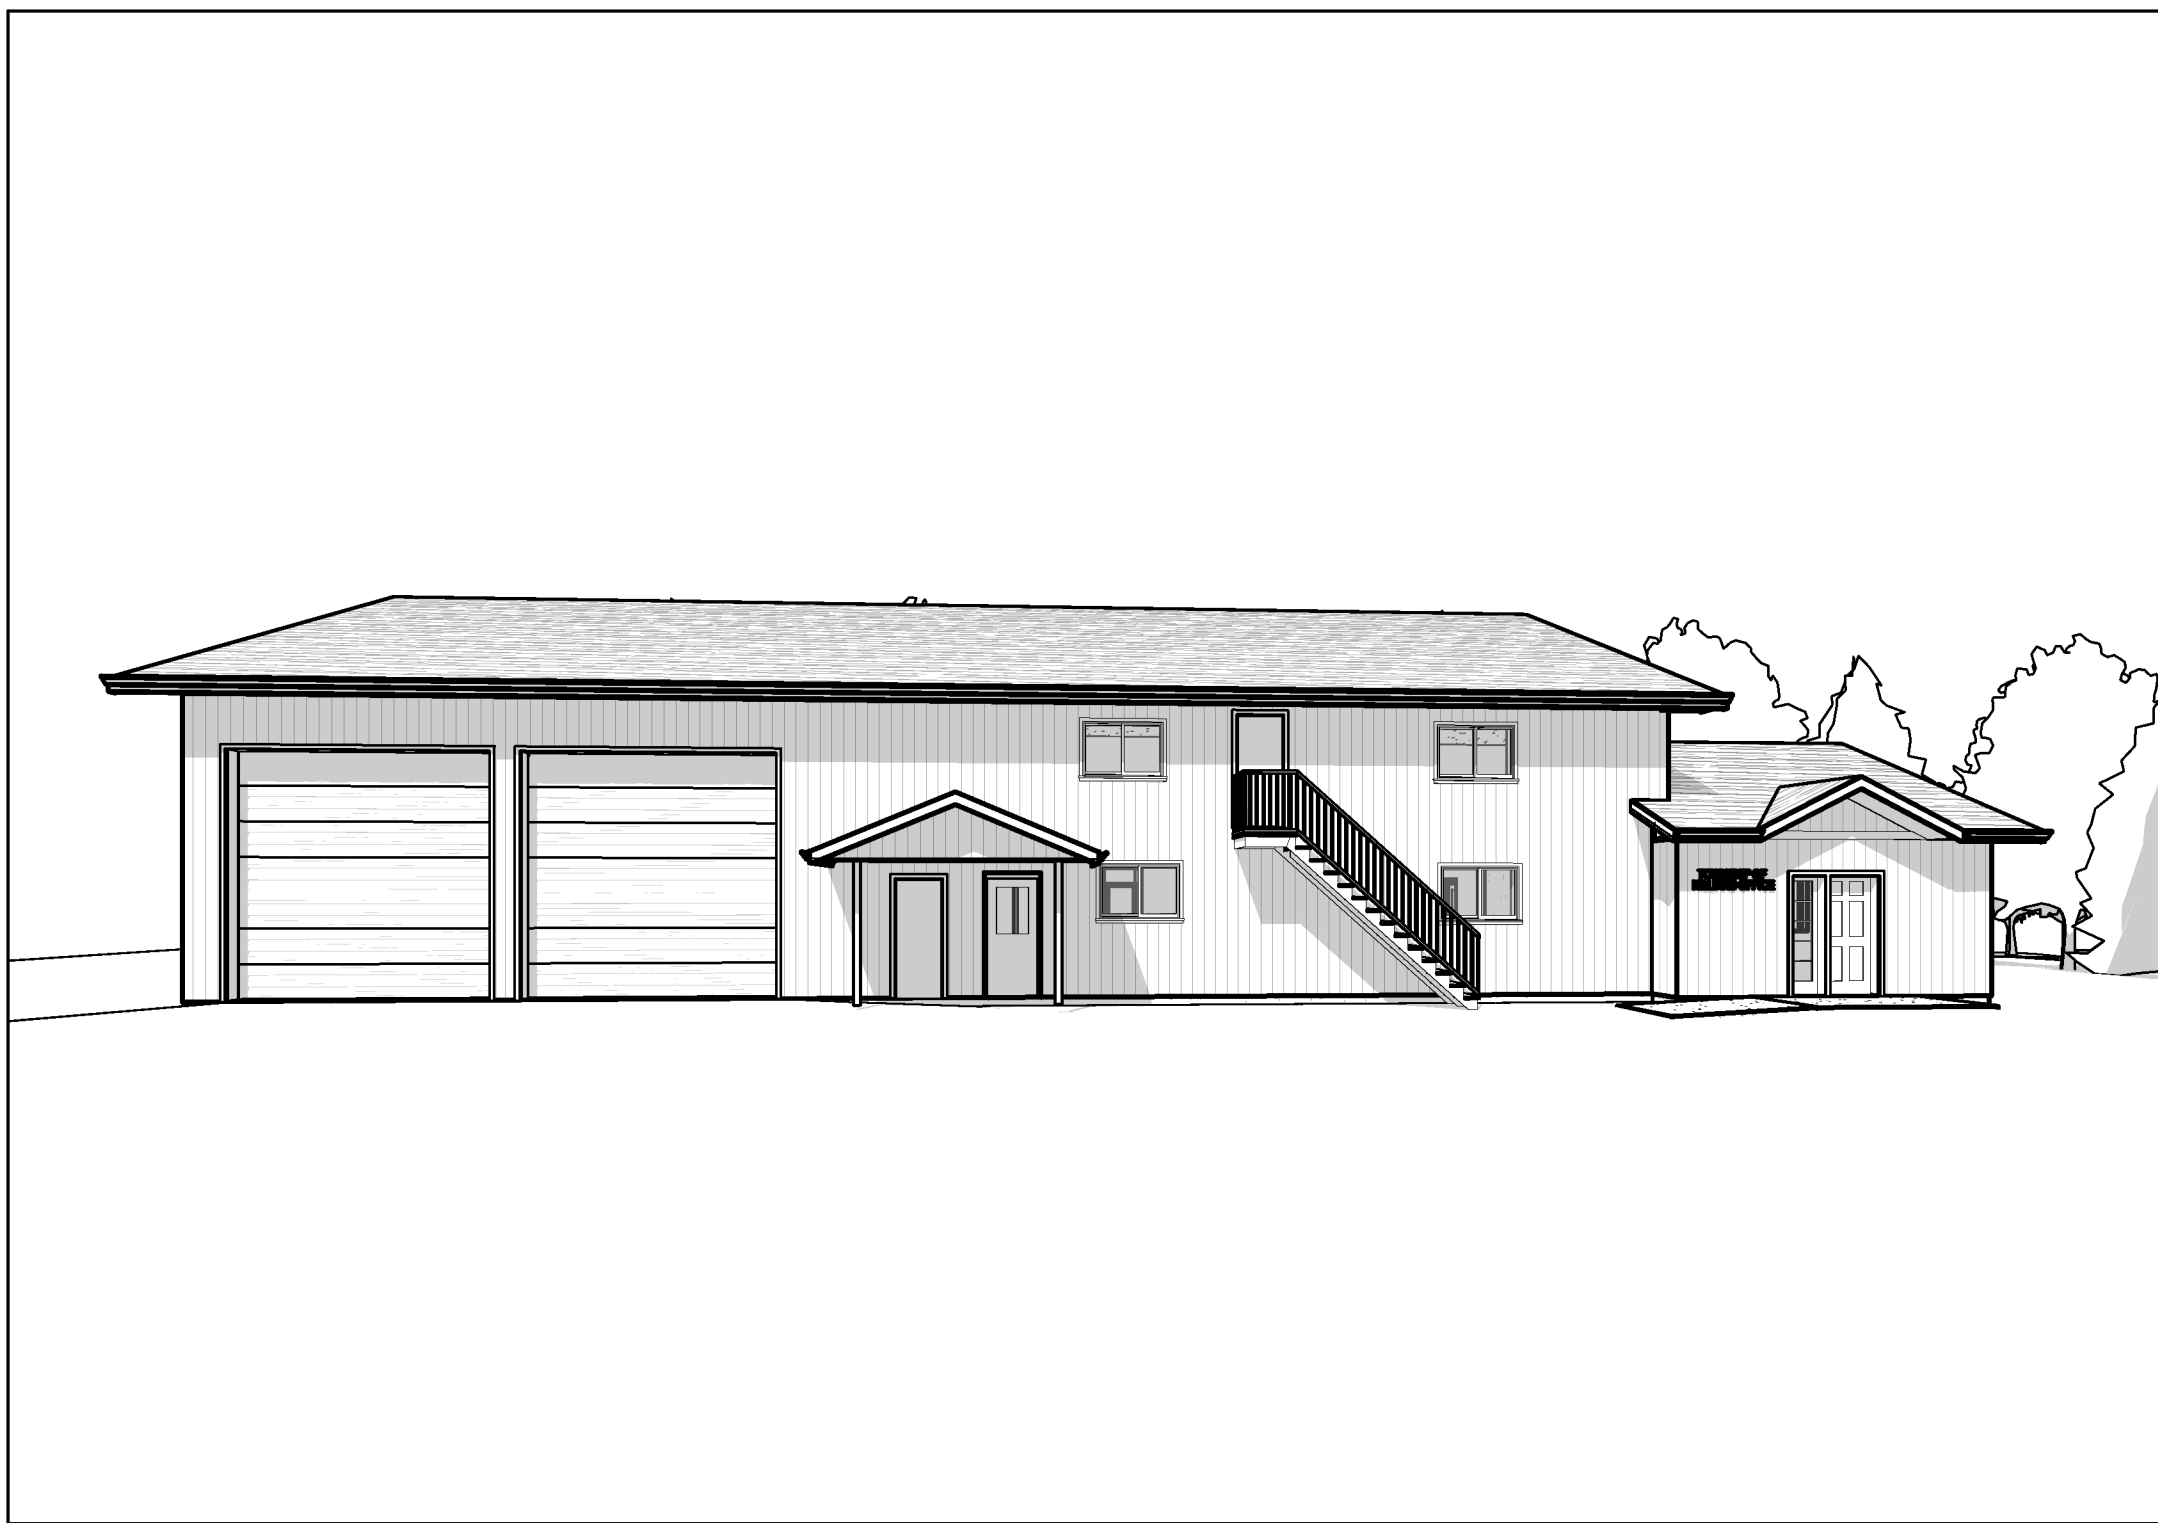

DATE STAMP: 2023-07-26 11:29:19 AM FILE PATH: D:\RIVARC\_Shared\Projects\2023\Hilliard\_Town\_Office\_Addition\2\_Working\Modell\2023\_Hilliard\_Town\_Office\_Addition\_Model.rvt



**ryancompanyarchitectinc**

Plan Orientation

Rev.	Description
1	Issued for Client Review
2	Issued for Tender

Date
23.04.14
23.07.26

Client



**EXTERIOR VIEWS**

Project Title  
 HILLIARD TOWNSHIP OFFICE ADDITION - PHASE 1  
 951678 Hwy 569, Hilliardton, ON, P0J 1L0

**Professional Stamp**  
\*I REVIEWED THIS DOCUMENT AND TAKE RESPONSIBILITY FOR THIS DESIGN. I AM QUALIFIED, AND THE FIRM IS REGISTERED, IN THE APPROPRIATE CLASSIFICATION AS PER SUBSECTION 3.2.4 OF DIVISION C OF THE BUILDING CODE.\*  
 RIVARC Sean Rivard  
 BCIN # 110013 BCIN # 102394  
*Sean Rivard*  
 SIGNATURE

Scale
Sheet Size 18 x 24"
Revision 2
Drawn By SWR

Project No.	Date	Drawing No.
22013	23.07.26	A11